
LINCOLN STREET AND EIGHTH STREET ROUNDABOUT

CITY OF STOCKTON

PROJECT NO. WT17021 FEDERAL PROJECT NO. CML-5008(176)

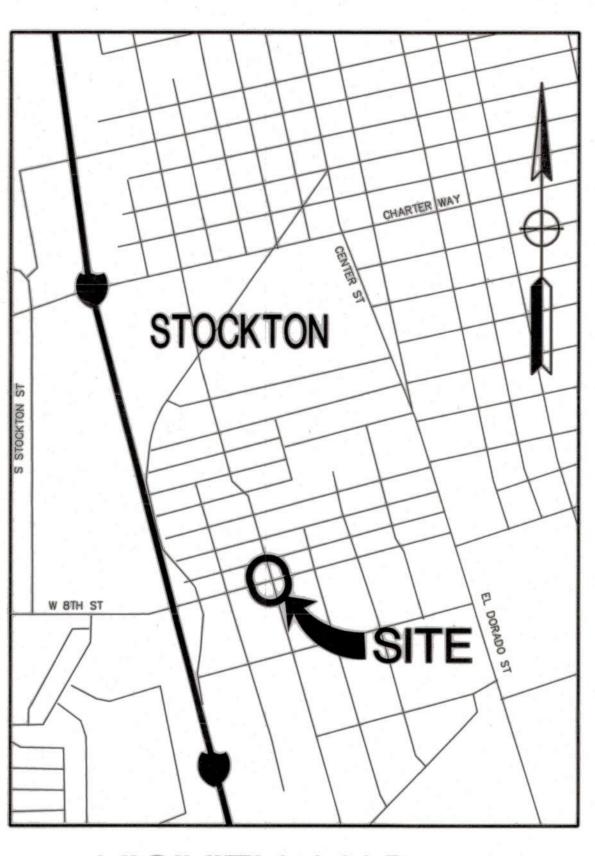


VICINITY MAP

NO SCALE

MARK THOMAS & CO. INC. 701 UNIVERSITY AVE, SUITE 200 SACRAMENTO CA, 95826 (916) 381-9100/FAX (916) 381-9180

Y&C TRANSPORTATION CONSULTANTS 3250 RAMOS CIRCLE SACRAMENTO CA, 95827 (916) 366-8000/FAX (916) 366-8008

BEFORE EXCAVATING
CALL U.S.A.
UNDERGROUND SERVICE ALERT
811
TOLL FREE
2 WORKING DAYS BEFORE ALL
PLANNED WORK OPERATIONS

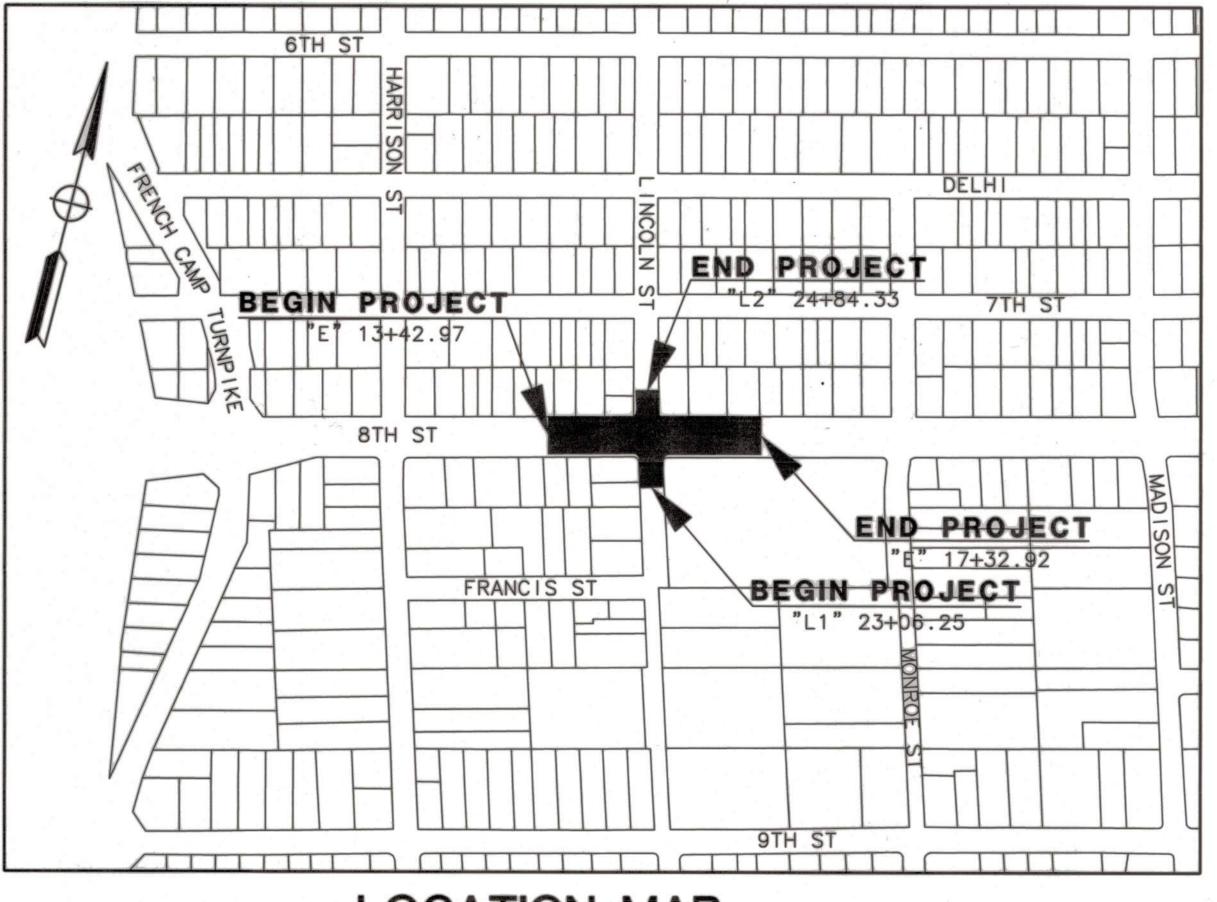

BASE BID

SH	EET No.		SHEET TITLE
	1	T-1	TITLE SHEET
	2-3	GN-1 TO GN-2	GENERAL NOTES
	4	SC-1	SURVEY CONTROL
	5-6	X-1 TO X-2	TYPICAL SECTIONS
	7	DE-1	DEMOLITION PLAN
	8	P-1	PAVING PLAN
	9-10	C-1 TO C-2	CONSTRUCTION DETAILS
	11	EC-1	EROSION CONTROL
	12-13	SS-1 TO SS-2	SIGNING AND STRIPING
	14-16	TH-1 TO TH-3	STAGING PLANS
	17	E-1	LIGHTING, CCTV & RRFB SYSTEMS
	18-22	E-2 TO E-6	ELECTRICAL PLANS
	23-26	L-1 TO L-4	LANDSCAPE PLANS

ALTERNATIVE BID

-			
	SHEET No.		SHEET TITLE
	27	DE-1A	DEMOLITION PLAN - ALT BID
	28-29	SS-1A TO SS-2A	SIGNING AND STRIPING - ALT BID

LOCATION MAP

NO SCALE

ORIGINAL SCALE IN INCHES
FOR REDUCED PLAN

1 2 3

PROFESSIONAL PROFE

Description

MARK

THOMAS

701 UNIVERSITY AVENUE, SUITE 200
SACRAMENTO, CALIFORNIA 95825

(916) 381-9100 FAX: (916)381-9180

LINCOLN ST./EIGHTH ST.
ROUNDABOUT PROJECT

TITLE SHEET

PUBLIC WORKS DEPARTMENT
CITY OF STOCKTON, CALIFORNIA

SCALE:

APPROVED BY: 3/16/22 SHEE

DESIGNED BY: 18

ECORD DWG:

DRAWN BY: LK

CHECKED BY: MM

DATE

T-1

OF 29 SHEA

STOCKTON, CALIFORNIA

THE TOTAL SHEAT IN THE TO

CITY OF STOCKTON STANDARD PLAN GENERAL NOTES

- ALL IMPROVEMENTS SHALL BE CONSTRUCTED IN STRICT ACCORDANCE WITH THE FOLLOWING: CURRENT CITY OF STOCKTON STANDARD SPECIFICATIONS AND PLANS, INCLUSIVE OF ALL CURRENT REVISIONS AND AMENDMENTS, CALIFORNIA DEPARTMENT OF TRANSPORTATION CURRENT STANDARD PLANS AND SPECIFICATIONS (CALTRANS), INCLUSIVE OF ALL CURRENT REVISIONS AND AMENDMENTS, AND CA-MUTCD LATEST EDITION, INCLUSIVE OF ALL CURRENT REVISIONS AND AMENDMENTS THERETO. WHERE THERE IS A CONFLICT BETWEEN THE PLANS AND THE CITY'S STANDARD SPECIFICATIONS AND PLANS, THE CITY OF STOCKTON STANDARD SPECIFICATIONS AND PLANS SHALL PREVAIL. CONTRACTOR SHALL BE RESPONSIBLE FOR CONSTRUCTING THE IMPROVEMENTS IN ACCORDANCE WITH THE ABOVE-MENTIONED STANDARDS AND SPECIFICATIONS.
- 2. THE CONTRACTOR SHALL VISIT THE SITE AND BECOME FAMILIAR WITH THE COMPLETE WORK SCOPE AND ALL RELATED CONDITIONS PRIOR TO BID. ANY QUESTIONS OR DISCREPANCIES WITH THE INFORMATION SHOWN HEREIN MUST BE DIRECTED TO THE ENGINEER PRIOR TO BID.
- 3. THE CONTRACTOR SHALL BE RESPONSIBLE FOR ALL PERMITS AND LICENSES REQUIRED FOR THE CONSTRUCTIONS AND COMPLETION OF THE PROJECT AND SHALL PERFORM ALL WORK IN ACCORDANCE WITH THE REQUIREMENTS AND CONDITIONS OF ALL PERMITS AND APPROVALS APPLICABLE TO THIS PROJECT. THE CONTRACTOR SHALL ENSURE THAT THE NECESSARY PERMITS AND/OR LICENSES ARE SECURED PRIOR TO CONSTRUCTION.
- 4. CONTRACTOR SHALL OBTAIN AN ENCROACHMENT PERMIT FROM THE CITY OF STOCKTON FOR ANY WORK DONE WITHIN CITY RIGHTS—OF—WAY OR ON CITY—OWNED FACILITIES WITHIN AN EASEMENT. CONTRACTOR SHALL CALL THE PERMIT CENTER AT (209) 937—8366 TO REQUEST A CONTROL NUMBER AND ACTIVATE THE PERMIT NO LESS THAN 24 HOURS, BUT NOT IN EXCESS OF 72 HOURS PRIOR TO START OF WORK.
- 5. ALL STATIONS REFER TO DISTANCES ALONG STREET CENTERLINE, UNLESS OTHERWISE NOTED. ALL STATIONS OFF CENTERLINE ARE PERPENDICULAR TO OR RADIALLY OPPOSITE CENTERLINE STATIONS.
- 6. THE CONTRACTOR SHALL RECEIVE PRIOR APPROVAL FROM THE ENGINEER FOR ANY EXTRA WORK. THE CONTRACTOR SHALL BE HELD RESPONSIBLE FOR ANY FIELD CHANGES MADE WITHOUT PRIOR WRITTEN AUTHORIZATION FROM THE ENGINEER AT NO ADDITIONAL COST TO THE CITY.
- 7. THE CONTRACTOR SHALL BE RESPONSIBLE FOR PROTECTING FROM DAMAGE ALL EXISTING AND NEWLY PLACED IMPROVEMENTS THAT ARE TO REMAIN. SUCH IMPROVEMENTS THAT ARE DAMAGED BY THE CONTRACTOR SHALL BE REPLACED AT NO ADDITIONAL COST TO THE CITY.
- 8. THE CONTRACTOR AGREES THAT HE SHALL ASSUME SOLE AND COMPLETE RESPONSIBILITY FOR JOB SITE CONDITIONS DURING THE COURSE OF CONSTRUCTION OF THIS PROJECT INCLUDING SAFETY AND SECURITY OF JOB SITE, THAT THIS REQUIREMENT SHALL APPLY CONTINUOUSLY AND NOT BE LIMITED TO NORMAL WORKING HOURS.

- 9. THE CONTRACTOR SHALL MAINTAIN A NEATLY MARKED SET OF FULL—SIZE AS—BUILT DRAWINGS SHOWING THE FINAL LOCATION OF FINAL IMPROVEMENTS.
 AS—BUILT DRAWINGS SHALL REFLECT CHANGE ORDERS, ACCOMMODATIONS, AND ADJUSTMENTS TO ALL IMPROVEMENTS CONSTRUCTED. WHERE NECESSARY, SUPPLEMENTAL DRAWINGS SHALL BE PREPARED AND SUBMITTED BY THE CONTRACTOR.
- 10. PRIOR TO ACCEPTANCE OF THE PROJECT, THE CONTRACTOR SHALL DELIVER TO THE ENGINEER, ONE SET OF NEATLY MARKED AS—BUILT DRAWINGS.

 AS—BUILT DRAWINGS SHALL BE REVIEWED AND THE COMPLETE AS—BUILT DRAWING SET SHALL BE CURRENT WITH ALL CHANGES AND DEVIATIONS REDLINED AS A PRECONDITION TO THE FINAL PROGRESS PAYMENT APPROVAL AND/OR FINAL ACCEPTANCE.
- 11.ALL TRENCH EXCAVATION SHALL BE IN ACCORDANCE WITH SECTION 7 OF THE CITY OF STOCKTON STANDARD SPECIFICATIONS.
- 12. THE CONTRACTOR SHALL PROVIDE ALL SHORING, BRACING, SLOPING OR OTHER PROVISIONS NECESSARY TO PROTECT WORKERS FOR ALL AREAS TO BE EXCAVATED TO A DEPTH OF 5' OR MORE. EXCAVATIONS OF 5 FEET OR MORE IN DEPTH WILL REQUIRE AN EXCAVATIONS PERMIT FROM THE STATE OF CALIFORNIA DEPARTMENT OF INDUSTRIAL SAFETY FOR TRENCHES 5 FEET OR MORE IN DEPTH, THE CONTRACTOR SHALL COMPLY WITH SECTION 7-1.02K(6)(B) OF THE CALTRANS STANDARDS, SECTION 6705 OF THE STATE OF CALIFORNIA LABOR CODE, AND ANY LOCAL CODES OR ORDINANCES.
- 13. ATTENTION IS CALLED TO: SECTION 1541(B)(1)
 OF THE CONSTRUCTION SAFETY ORDERS (CALIFORNIA
 CODE OF REGULATIONS, TITLE 8), ISSUED BY THE
 OCCUPATIONAL SAFETY AND HEALTH STANDARDS
 BOARD PURSUANT TO THE CALIFORNIA OCCUPATIONAL
 SAFETY AND HEALTH ACT OF 1973, WHICH STATES:
 "THE APPROXIMATE LOCATION OF SUBSURFACE
 INSTALLATIONS, SUCH AS SEWER, TELEPHONE,
 FUEL, ELECTRIC, WATER LINES, OR ANY OTHER
 SUBSURFACE INSTALLATIONS THAT REASONABLY MAY
 BE EXPECTED TO BE ENCOUNTERED DURING
 EXCAVATION WORK, SHALL BE DETERMINED BY THE
 EXCAVATOR PRIOR TO OPENING AN EXCAVATION."
- 14.PRIOR TO COMMENCING ANY WORK, IT SHALL BE THE CONTRACTOR'S RESPONSIBILITY TO HAVE EACH UTILITY COMPANY LOCATE IN THE FIELD THEIR MAIN AND SERVICE LINES. THE CONTRACTOR SHALL NOTIFY MEMBERS OF THE UNDERGROUND SERVICE ALERT (U.S.A.) 48 HOURS IN ADVANCE OF PERFORMING EXCAVATION WORK BY CALLING THE TOLL—FREE NUMBER (800) 227—2600.
- 15.IT SHALL BE CONTRACTOR'S SOLE RESPONSIBILITY
 TO PROTECT ALL EXISTING UTILITIES SO THAT NO
 DAMAGE RESULTS TO THEM DURING THE PERFORMANCE
 OF HIS CONTRACT. THE CONTRACTOR SHALL BE
 REQUIRED TO COOPERATE WITH OTHER CONTRACTORS
 AND UTILITY COMPANIES INSTALLING NEW OR
 MODIFIED STRUCTURES, UTILITIES AND SERVICES
 WITHIN THE PROJECT LIMITS.
- 16. THE CONTRACTOR SHALL EXERCISE DUE CAUTION AND SHALL CAREFULLY PRESERVE BENCH MARKS, CONTROL POINTS, REFERENCE POINTS AND ALL

- SURVEY MONUMENTS, AND SHALL BEAR ALL EXPENSES FOR REPLACEMENT AND/OR ERROR CAUSED BY HIS UNNECESSARY LOSS OR DISTURBANCE. THE CONTRACTOR SHALL CONSULT WITH A LICENSED LAND SURVEYOR OR CIVIL ENGINEER LICENSED TO PRACTICE LAND SURVEYING IN CALIFORNIA PRIOR TO BEGINNING CONSTRUCTION TO ENSURE THAT ANY PRECONSTRUCTION CORNER RECORDS, AS REQUIRED BY THE STATE OF CALIFORNIA PROFESSIONAL LAND SURVEYOR ACT HAVE BEEN FILED WITH THE COUNTY SURVEYOR, PURSUANT TO SECTION 8771 (A-F) OF THE CALIFORNIA BUSINESS AND PROFESSION CODE.
- 17. ALL WORK IN THE PUBLIC RIGHT-OF-WAY IS SUBJECT TO THE APPROVAL AND ACCEPTANCE OF THE ENGINEER.
- 18.PRIOR TO PLACEMENT OF ANY FINISH ASPHALT CONCRETE OR CONCRETE, THE CONTRACTOR SHALL VERIFY ALL FINISH GRADES AND SLOPES FOR COMPLIANCE WITH THE AMERICANS WITH DISABILITIES ACT (ADA) AND OBTAIN APPROVAL AND ACCEPTANCE BY THE ENGINEER.
- 19. THE CONTRACTOR SHALL LAYOUT IMPROVEMENTS
 FROM THE DIMENSIONS SHOWN ON THE PLANS. ANY
 CLARIFICATION OR CONFLICTS, DISCREPANCIES OR
 AMBIGUITIES SHALL BE DIRECTED TO THE ENGINEER
 PRIOR TO THE CONSTRUCTION OF THE
 IMPROVEMENTS.
- 20.DUST CONTROL SHALL BE PERFORMED AT ALL TIMES, AT THE CONTRACTORS' EXPENSE, TO MINIMIZE ANY DUST NUISANCE AND SHALL BE IN ACCORDANCE WITH SECTION 10-5 OF CALTRANS STANDARD SPECIFICATIONS AND THE REQUIREMENTS OF THE CITY OF STOCKTON.
- 21. THE CONTRACTOR SHALL MAINTAIN ALL EXISTING WATER, SEWER, AND DRAINAGE FACILITIES WITHIN THE CONSTRUCTION AREA UNTIL NEW IMPROVEMENTS ARE IN PLACE AND FUNCTIONING, EXCEPT WHERE OTHERWISE APPROVED.
- 22.INGRESS AND EGRESS BY PROPERTY OWNERS, BUSINESSES, AND OTHERS SHALL BE PROVIDED AT ALL TIMES DURING THE COURSE OF CONSTRUCTION UNLESS OTHERWISE APPROVED OR SPECIFIED.
- 23.SIDEWALK REMOVAL SHALL BE TO THE NEAREST SCORE MARK OR AS DETERMINED BY THE ENGINEER. CONTRACTOR SHALL NEATLY SAW—CUT CONCRETE WHERE PULL BOXES ARE TO BE PLACED AND SHALL RESTORE THE SLAB TO MATCH THE EXISTING CONDITION.

STRIPING AND SIGNAGE NOTES:

- THE CONTRACTOR SHALL PROVIDE ALL LIGHTS, BARRICADES, SIGNS, FLAGMEN OR OTHER DEVICES NECESSARY FOR PUBLIC SAFETY.
- THE CONTRACTOR SHALL SUBMIT A TRAFFIC CONTROL AND/OR DETOUR PLAN FOR APPROVAL BY THE CITY OF STOCKTON TRAFFIC ENGINEER PRIOR TO THE START OF CONSTRUCTION.
- ALL PAVEMENT MARKINGS, STRIPING AND CROSSWALKS SHALL BE THERMOPLASTIC.
- 4. STRIPING AND PAVEMENT MARKINGS SHALL BE IN STRICT CONFORMANCE WITH THE CA-MUTCD (LATEST

- EDITION) AND THE SPECIAL PROVISIONS SECTION 84. LONGITUDINAL STRIPING EXCLUDED, PAVEMENT MARKINGS SHALL ALSO CONFORM TO THE CALTRANS SPECIFICATIONS (LATEST EDITION) SECTION 84.
- SIGNING SHALL CONFORM TO THE CA-MUTCD (LATEST EDITION) AND CALTRANS SPECIFICATIONS (LATEST EDITION) SECTION 82.
- REMOVAL OF EXISTING PAVEMENT MARKINGS SHALL BE REMOVED BY GRINDING PER CALTRANS STANDARD SPECIFICATIONS SECTION 84—9.
- CONTRACTOR SHALL INSTALL A BLUE REFLECTOR ON FIRE HYDRANT SIDE AT ALL FIRE HYDRANT LOCATIONS PER CA-MUTCD, SECTION 3B.11 AND FIGURE 3B-102.
- 8. THE CONTRACTOR SHALL NOTIFY THE ENGINEER A MINIMUM OF TWO (2) WORKING DAYS IN ADVANCE TO VERIFY THE LAYOUT AND CAT—TRACKING OF THE PROPOSED IMPROVEMENTS. CAT—TRACKING TO BE APPROVED BY TRAFFIC ENGINEERING PRIOR TO FINAL ACCEPTANCE OF STRIPING AND PAVEMENT MARKINGS.
- 9. THE CONTRACTOR SHALL ENSURE THAT THE APPROPRIATE STRIPING AND PAVEMENT MARKINGS ARE IN PLACE AT ALL TIMES. TEMPORARY STRIPING AND/OR PAVEMENT MARKINGS SHALL BE INSTALLED TO REPLACE ANY EXISTING STRIPING OR MARKINGS WHICH HAVE BEEN REMOVED. ANY CONFLICTING STRIPING SHALL BE REMOVED IMMEDIATELY BY THE CONTRACTOR PRIOR TO REOPENING THE STREET TO TRAFFIC.
- 10. THE CONTRACTOR SHALL REMOVE ANY EXISTING SIGNS IN CONFLICT WITH THESE PLANS AS DIRECTED BY THE CITY TRAFFIC ENGINEER. EXISTING STRIPING AND MARKINGS IN CONFLICT WITH THESE PLANS SHALL BE REMOVED BY THE CONTRACTOR. PAVEMENT SHALL BE REPAIRED IF DAMAGED IN CONJUNCTION WITH REMOVAL OF MARKERS.
- 11.R30E (CA) "NO PARKINGO SIGNS ARE TO BE INSTALLED AT A 45% ANGLE FACING DIRECTION OF TRAFFIC FLOW. SIGN SIZE SHALL BE 180 X 240.
- 12.ALL DIMENSIONS SHOWN ARE FROM FACE OF CURB, UNLESS OTHERWISE NOTED.
- 13. THE CONTRACTOR SHALL REPLACE ANY PAVEMENT DELINEATION AND TRAFFIC MARKINGS THAT ARE DAMAGED DURING THE COURSE OF WORK AT NO ADDITIONAL COST TO THE CITY.

TRAFFIC AND ELECTRICAL NOTES:

- 1. INSTALLATION OF NEW CONDUCTORS INTO EXISTING CONDUIT SHALL BE IN ACCORDANCE WITH SECTION 77-1.12 OF THE SPECIAL PROVISIONS. PRIOR TO INSTALLATION OF NEW CONDUCTORS/CABLES IN EXISTING CONDUITS, THE CONTRACTOR SHALL USE CABLE LOOSENER TO LOOSEN THE CONDUITS. THE CONTRACTOR SHALL ALSO USE PULLING LUBRICANT FOR PULLING WIRES, AND A PULL TAPE CONFORMING TO THE PROVISION DESCRIBED UNDER "CONDUITO, ELSEWHERE IN THE SPECIAL PROVISIONS.
- 2. POLES, PULL BOXES, DETECTOR HANDHOLES,


- INDUCTIVE LOOPS AND CONTROLLER CABINET LOCATIONS SHALL BE LOCATED IN THE FIELD BY THE CONTRACTOR WITH THE APPROVAL OF THE CITY TRAFFIC ENGINEER. TYPICALLY, DETECTOR HANDHOLES SHOULD BE INSTALLED ON LANE LINES.
- . CONTRACTOR SHALL MEET GENERAL ORDER (G.O.) 95
 REQUIREMENTS AND LOCATE FOUNDATIONS SO AS TO
 PROVIDE A MINIMUM OF 6' RADIAL CLEARANCE FROM
 ALL EQUIPMENT TO OVERHEAD POWER LINES
 (PRIMARY) AND A MINIMUM OF 3' RADIAL
 CLEARANCE TO COMMON NEUTRAL LINES. SIGNAL
 POLES SHALL BE LOCATED TO PROVIDE A MINIMUM
 OF 10' RADIAL CLEARANCE TO PRIMARY LINES.
 CONTRACTOR SHALL BE RESPONSIBLE FOR ANY COSTS
 ASSOCIATED WITH WORKING WITHIN THE 10' RADIAL
 CLEARANCE ZONE.
- 4. CONDUIT ROUTING IS SHOWN DIAGRAMMATICALLY.
 CONTRACTOR SHALL LAYOUT RUNS TO SUIT FIELD
 CONDITIONS AND THE COORDINATION REQUREMENTS
 OF UTILITIES OR ANY OTHER TRADES, AND TO THE
 SATISFACTION OF THE CITY OF STOCKTON. UPON
 COMPLETION OF CONDUIT INSTALLATION, THE
 ACTUAL LOCATION OF THE CONDUITS SHALL BE
 NOTED ON AN AS-BUILT SET OF PRINTS AND
 FURNISHED TO THE CITY.
- LABEL PEDESTRIAN AND SIGNAL COMMONS SEPARATELY IN THE CONTROLLER CABINET.

BEFORE EXCAVATING
CALL U.S.A.
UNDERGROUND SERVICE ALERT
811
TOLL FREE
2 WORKING DAYS BEFORE ALL

PLANNED WORK OPERATIONS

ORIGINAL SCALE IN INCHES
FOR REDUCED PLAN

1 2 3

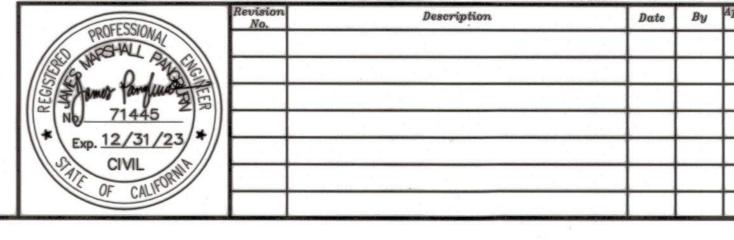

MARK
THOMAS

701 UNIVERSITY AVENUE, SUITE 200 SACRAMENTO, CALIFORNIA 95825 (916) 381-9100 FAX: (916) 381-9180

LINCOLN ST./EIGHTH ST.
ROUNDABOUT PROJECT

GENERAL NOTES

PUBLIC WORKS DEPARTMENT CITY OF STOCKTON, CALIFORNIA

SCALE: NOT TO SCALE

DESIGNED BY: LK

DRAWN BY: LK

CHECKED BY: MM

RECORD DWG:

DATE

CITY ENGINEER
STOCKTON, CALIFORNIA

TE GN-1

OF 29 SHEETS

WT17021

PROJECT NO.

CITY OF STOCKTON STANDARD PLANS

DRAWING NUMBER	DESCRIPTION
R-11	TYPICAL SINGLE ROUNDABOUT
R-30	ADJUSTING STREET FACILITIES
R-31	TO GRADE MEDIAN CURBING OVER
R-50 R-51	EXISTING PAVEMENT SIDEWALK DETAILS
R-52	ROLL CURB, GUTTER & SIDEWALK
R-53	VERTICAL CURB, GUTTER & SIDEWALK ROLL CURB TO VERTICAL CURB TRANSITION
R-55	CONCRETE CURB, GUTTER & SIDEWALK
	CONSTRUCTION STANDARDS
R-64	TYPICAL WHEELCHAIR RAMP
	AT INTERSECTIONS
R-66	SPECIAL WHEELCHAIR RAMP
D 07	AT MIDBLOCK
R-87 R-88	CONDUIT PULL BOX
N-00	RESIDENTIAL STREET LIGHTS TYPE AND
R-89	LIGHT POLE FOUNDATION TYPE 15
R-109	STREET NAME & TRAFFIC SIGN
	INSTALLATION DETAIL & NOTES
S-9	MAINTENANCE HOLE FRAME & COVER
D-8	ADJUSTMENT CURB INLET CATCH BASIN TYPE 2
W-11	VALVE BOX DETAILS

CALTRANS STANDARD PLANS 2018

DRAWI	NG	NUMB	ER

DESCRIPTION FIGURE

A24A-F

CA MUTCD 2014 Ed. Rev 5 -3A-101-108 STRIPING DETAILS.

PAVEMENT MARKINGS - ARROWS, SYMBOLS, NUMERALS, WORDS AND CROSSWALKS

A73A A88B

OBJECT MARKERS CURB RAMP AND ISLAND PASSAGEWAY DETAILS

UTILITY LEGEND:

EXISTIN	NG	P	PROPOSED				
○○○○	MAINTENANCE HOLE WATER VALVE		CONDU	TRICAL JIT N INLET			
	DRAIN INLET						
s	SANITARY SEWER						
sd	STORM DRAINAGE						
	WATER						
tc	CABLE (COMCAST	OR AT&T)					
j +(oh)	JOINT OVERHEAD (AT&T, COMCAST, CROWN CASTLE)	PG&E,					

	UTILITY C	ONTACT TABLE	
UTILITY AGENCY	CONTACT PERSON	ADDRESS	PHONE NUMBER
AT&T	SHARON DINNELL	1116 M STREET, ROOM 200 MODESTO, CA 95354	(209) 549-5847
COMCAST	DARRIN EATON	6505 TAM O'SHANTER DR. STOCKTON, CA 95210	(952) 724-9067
PG&E	BRAD JOAQUIN	4040 WEST LANE, BLDG 9 STOCKTON, CA 95204	(209) 601-7089
CAL WATER	JEREMIAH MECHAM	1505 E.SONORA STREET STOCKTON, CA 95205	(209) 547-7900
CROWN CASTLE	SAUL VALVERDE	4044 CLIPPER COURT FREMONT, CA 94538	(925) 701-7187

BEFORE EXCAVATING CALL U.S.A.
UNDERGROUND SERVICE ALERT 811 TOLL FREE 2 WORKING DAYS BEFORE ALL PLANNED WORK OPERATIONS

ABBREVIATIONS

VRRK	EVIATIONS		
AB	AGGREGATE BASE	00	ON CENTER
	ASPHALT CONCRETE	OG	ORIGINAL GROUND
	ANGLE POINT	PB	PULLBOX
AS	AGGREGATE SUBBASE	PCC	POINT OF COMPOUND CURVE
73	ACCRECATE SOBBASE	FCC	
REC	RECIN	DC.	OR PORTLAND CEMENT CONCRETE
DEG DEG	BEGIN CURVE		PROFILE GRADE
DL DI	BLUE LANE		PROPERTY LINE
DCW/	BIKE LANE BACK OF SIDEWALK BEGIN VERTICAL	POC	POINT ON CURVE
BZM	BACK OF STDEWALK	PRC	POINT OF REVERSING CURVES
BAC	DEOTH VERTIONE	PROP	PROPOSED
	CURVE		POINT
			PUBLIC UTILITY EASEMENT
	CURB & GUTTER		POINT OF VERTICAL INTERSECTION
€.	CENTERLINE	PVMT	PAVEMENT
CL	CLASS, CHAIN LINK		RADIUS
CONC	CONCRETE CONST CONSTRUCT	RCP	REINFORCED CONCRETE PIPE
COS	CITY OF STOCKTON	RD	ROAD
CR	CURB RAMP CALIFORNIA COORDINATE SYSTEM	REM	REMOVE
CCS	CALIFORNIA COORDINATE SYSTEM	RET	RETAINING
		RIM	MANHOLE RIM ELEVATION
DI	DROP INIFT/DRAIN INIFT	ROW R/W	RIGHT OF WAY
DIA	DROP INLET/DRAIN INLET DIAMETER	DD NOW, NOW	REFERENCE POINT
		RT OR R	
D/W	DRIVEWAY		
		S	
		SAW	
	ELECTRICAL LINE		SOUTHBOUND
	EASTBOUND	SD	STORM DRAIN
	ELECTROLIER OR END CURVE		STREET NAME SIGN
ELEV	ELEVATION	SRTS	SAFE ROUTES TO SCHOOL
EP	EDGE OF PAVEMENT	SS	SANITARY SEWER
EVC	END VERTICAL CURVE	SSCO	SANITARY SEWER CLEANOUT
EX/	EXISTING	STA	STATION(S)
EXIST		STD	STANDARD STD
LATO!		SW	SIDEWALK SW
HMA	HOT MIX ASPHALT (TYPE A)		
HP	HIGH POINT	TEL/T	TELEPHONE LINE
HT	HEIGHT		TOP BACK OF CURB
			TEMPORARY CONSTRUCTION EASEMENT
	INVERT OF PIPE		TOP FACE OF CURB
	IRRIGATION	TYP	TYPICAL
	LINEAR FOOT	TIF	TIPICAL
	LIP OF GUTTER	LIC	LINDEBOROLIND
LT	LEFT	UG	UNDERGROUND
OR		MAD	VARIABLE VARIES
LT			VARIABLE, VARIES
LOL	LAYOUT LINE		VERTICAL CURVE
LP	LOW POINT		VALLEY GUTTER
		VERT	VERTICAL
MAX	MAXIMUM		
MH	MAINTENANCE HOLE	W	WATER LINE
MOD	MODIFIED		WESTBOUND
		WV	WATER VALVE
(N)	NOT A PAY ITEM		
NB	NORTHBOUND		
NTS	NOT TO SCALE		

	UTILITY C	ONTACT TABLE	
TY	CONTACT PERSON	ADDRESS	PHONE NUMBER
	SHARON DINNELL	1116 M STREET, ROOM 200 MODESTO, CA 95354	(209) 549–5847
AST	DARRIN EATON	6505 TAM O'SHANTER DR. STOCKTON, CA 95210	(952) 724-9067
	BRAD JOAQUIN	4040 WEST LANE, BLDG 9 STOCKTON, CA 95204	(209) 601-7089
ATER	JEREMIAH MECHAM	1505 E.SONORA STREET STOCKTON, CA 95205	(209) 547-7900
CASTLE	SAUL VALVERDE	4044 CLIPPER COURT FREMONT, CA 94538	(925) 701-7187

ORIGINAL SCALE IN INCHES

FOR REDUCED PLAN

LINCOLN ST./EIGHTH ST. ROUNDABOUT PROJECT GENERAL NOTES

PUBLIC WORKS DEPARTMENT CITY OF STOCKTON, CALIFORNIA

SCALE: NOT TO SCALE
DESIGNED BY: LK DRAWN BY: LK CHECKED BY: MM RECORD DWG: 5397.2C

MARK

THOMAS


701 UNIVERSITY AVENUE, SUITE 200 SACRAMENTO, CALIFORNIA 95825 (916) 381-9100 FAX: (916) 381-9180

GENERAL NOTES: LEGEND BASIS OF BEARING 1. CONTRACTOR SHALL COMPLY WITH BUSINESS AND PROFESSIONS CODE SECTION 8771 (b) REGARDING REFERENCING, PRESERVING CONTROL POINT COORDINATES SHOWN ARE CCS83(2011), ZONE 3 EPOCH AND RECONSTRUCTIONING MONUMENTS, WHETHER OR NOT 2017.50. ELEVATIONS SHOWN ARE NAVD88. MONUMENTS ARE SHOWN IN THESE PLANS. COORDINATES AND ELEVATIONS SHOWN ARE IN U.S. MONUMENT 2. IF MONUMENT IS DAMAGED BY CONTRACTOR'S OPERATIONS, SURVEY FEET. AN AVERAGE COMBINED FACTOR OF 0.99994 WILL BE USED FOR THIS PROJECT. DIVIDE WHETHER OR NOT MONUMENTS ARE SHOWN ON THESE PLANS, GRID DISTANCE BY 0.99994 TO OBTAIN GROUND CONTRACTOR SHALL REPLACE AT CONTRACTORS COST. DISTANCES. 0 END "L2" LINE 26+00.00 N 2161388.67 Z E 6333728.41 N14 29 35 W Beg "L2" LINE 24+00.00 N 2161195.04 E 6333778.46 Beg "E" LINE "E" LINE 8TH ST 10+00.00 N75 27 20 E END "E" LINE N 2161061.03 21+50.00 113 50.0014 E 6333261.93 N 2161349.83 E 6334375.07 N17 END "L1" LINE 24+00.00 N 2161196.14 E 6333782.71 ST FRANCIS ST Beg "L1" LINE 22+00.00 N 2161005.10 E 6333841.91 1001 SURVEY CONTROL TABLE NUMBER EASTING ELEVATION DESCRIPTION NORTHING SET CUT 'X' 1000 2161179.740 6333841.330 11.42 1001 SET CUT 'X' 2160773.820 6333936.930 12.90 1002 633684.140 SET CUT 'X' 2161467.100 11.25 FOUND IRON ROD-3000 2160398.250 6334029.970 12.93 LINCOLN& W 9TH ST LINCOLN ST./EIGHTH ST. ROUNDABOUT PROJECT 3000 SVMON FND IRON ROD 3001 6334786.010 2161456.440 11.91 9TH ST MADISON & W 8TH ST SURVEY CONTROL Description Date By PUBLIC WORKS DEPARTMENT CITY OF STOCKTON, CALIFORNIA MARK BEFORE EXCAVATING **THOMAS** CALL U.S.A. SCALE: UNDERGROUND SERVICE ALERT ORIGINAL SCALE IN INCHES DESIGNED BY: LK 811 FOR REDUCED PLAN 701 UNIVERSITY AVENUE, SUITE 200 SACRAMENTO, CALIFORNIA 95825 TOLL FREE DRAWN BY: LK 2 WORKING DAYS BEFORE ALL (916) 381-9100 FAX: (916) 381-9180 CHECKED BY: MM PLANNED WORK OPERATIONS

5397.3C


STOCKTON, CALIFORNIA

RECORD DWG:

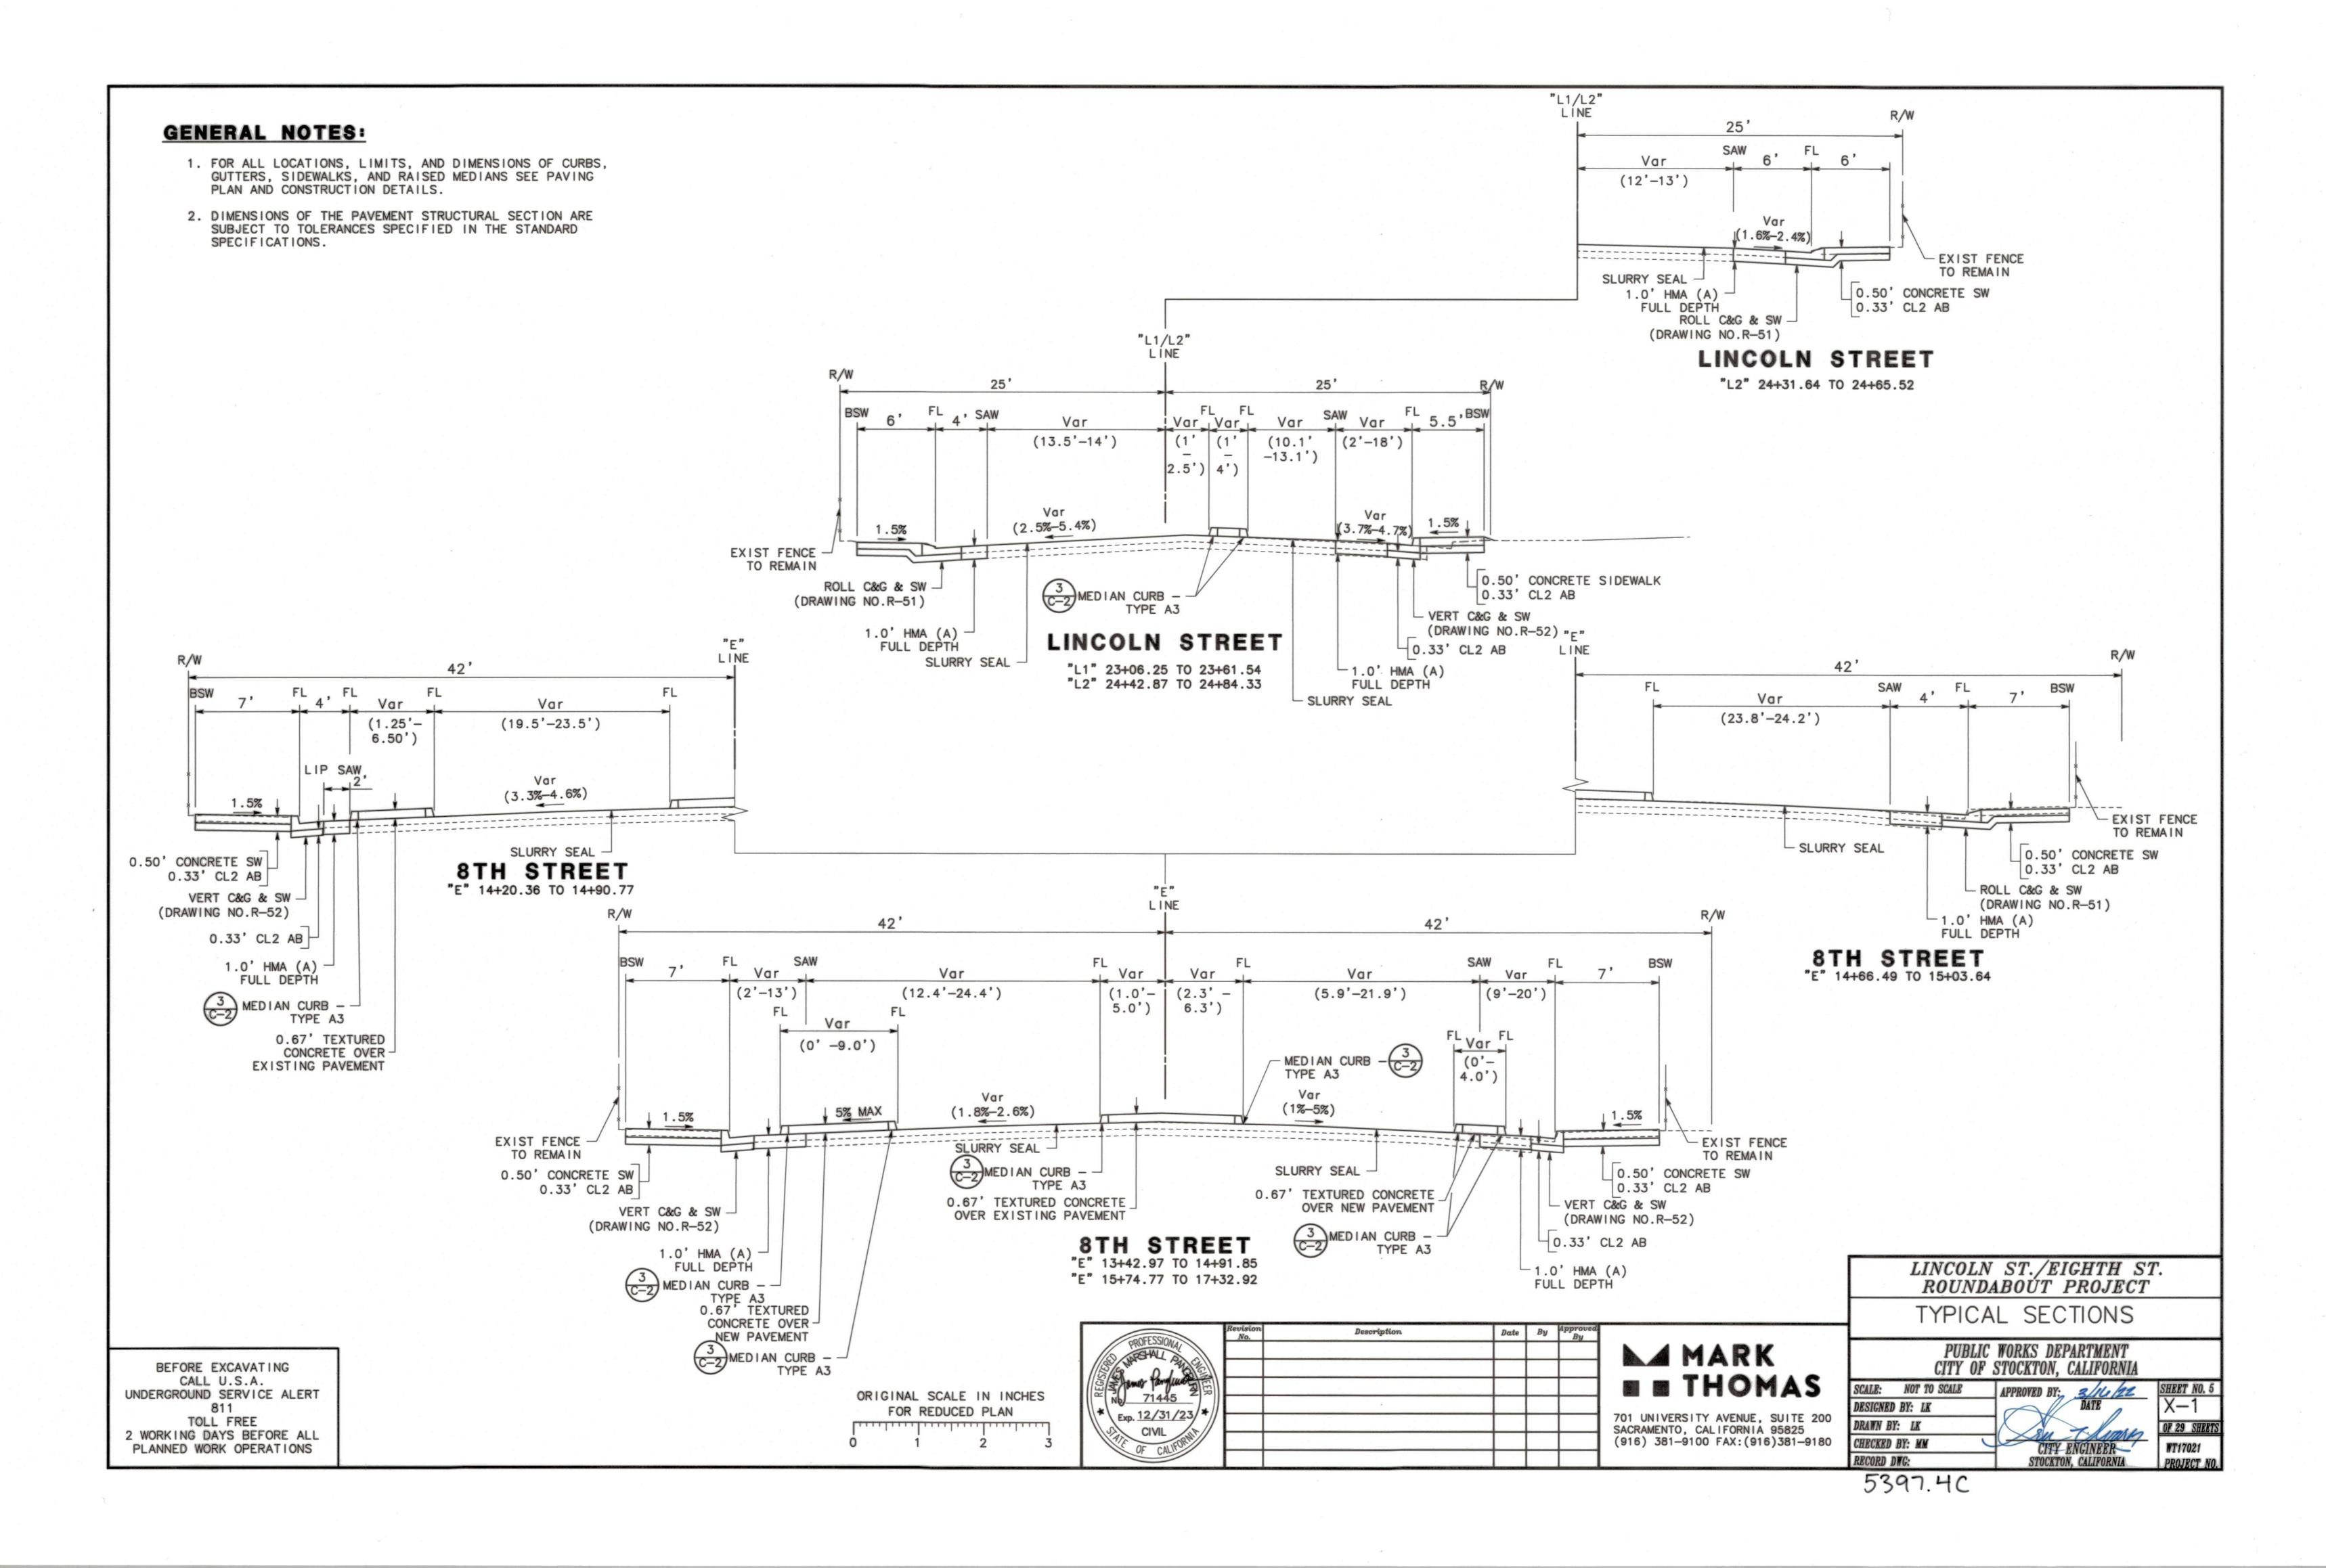

GENERAL NOTES:

- FOR ALL LOCATIONS, LIMITS, AND DIMENSIONS OF CURBS, GUTTERS, SIDEWALKS, AND RAISED MEDIANS SEE PAVING PLAN AND CONSTRUCTION DETAILS.
- DIMENSIONS OF THE PAVEMENT STRUCTURAL SECTION ARE SUBJECT TO TOLERANCES SPECIFIED IN THE STANDARD SPECIFICATIONS.

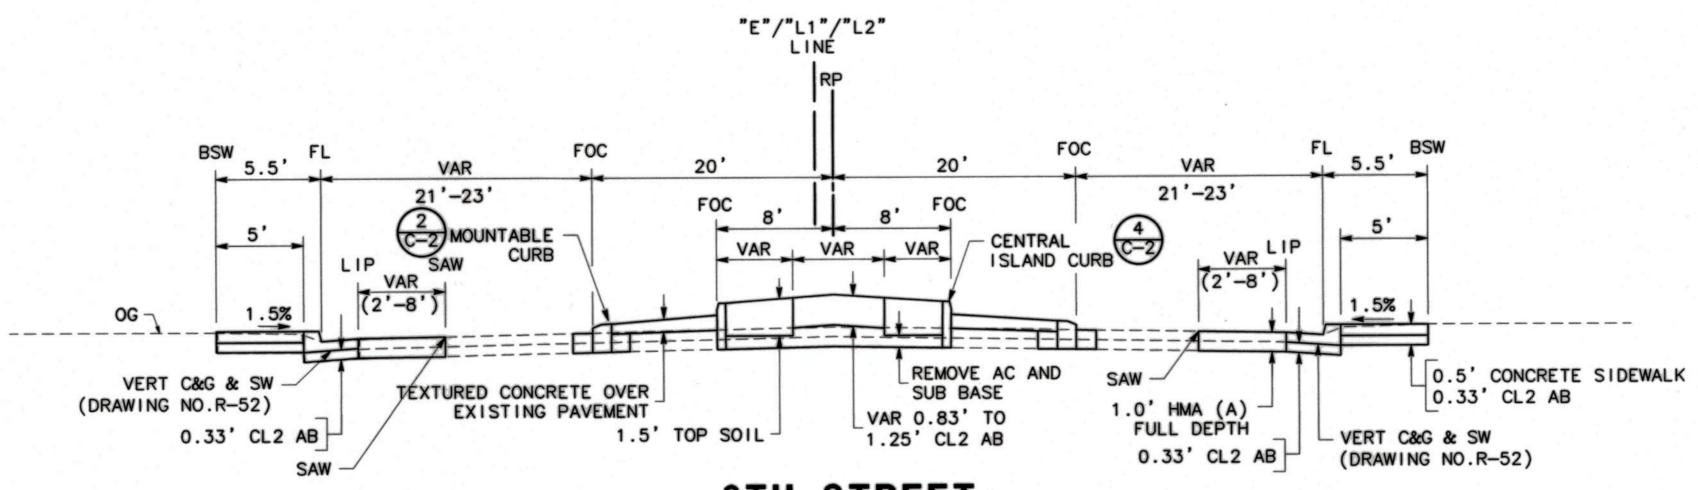


8TH STREET LINCOLN STREET

"E" 14+91.85 TO 15+74.77
"L1" 23+61.54 TO 24+00.00
"L2" 24+00.00 TO 24+42.87

BEFORE EXCAVATING
CALL U.S.A.
UNDERGROUND SERVICE ALERT
811
TOLL FREE
2 WORKING DAYS BEFORE ALL
PLANNED WORK OPERATIONS

ORIGINAL SCALE IN INCHES
FOR REDUCED PLAN
0 1 2

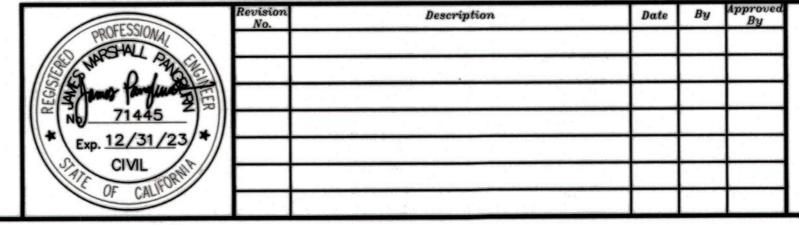

MARK
THOMAS

701 UNIVERSITY AVENUE, SUITE 200 SACRAMENTO, CALIFORNIA 95825 (916) 381-9100 FAX:(916)381-9180 LINCOLN ST./EIGHTH ST. ROUNDABOUT PROJECT

TYPICAL SECTIONS

PUBLIC WORKS DEPARTMENT
CITY OF STOCKTON, CALIFORNIA

SCALE: NOT TO SCALE APPROVED BY: 3/12/27
DESIGNED BY: LK

SCALE: NOT TO SCALE

DESIGNED BY: LK

DRAWN BY: LK

CHECKED BY: MM

RECORD DWG:

OVED BY:

DATE


SHEET NO. 6


X-2

OF 29 SHEETS

WT17021

PROJECT NO.

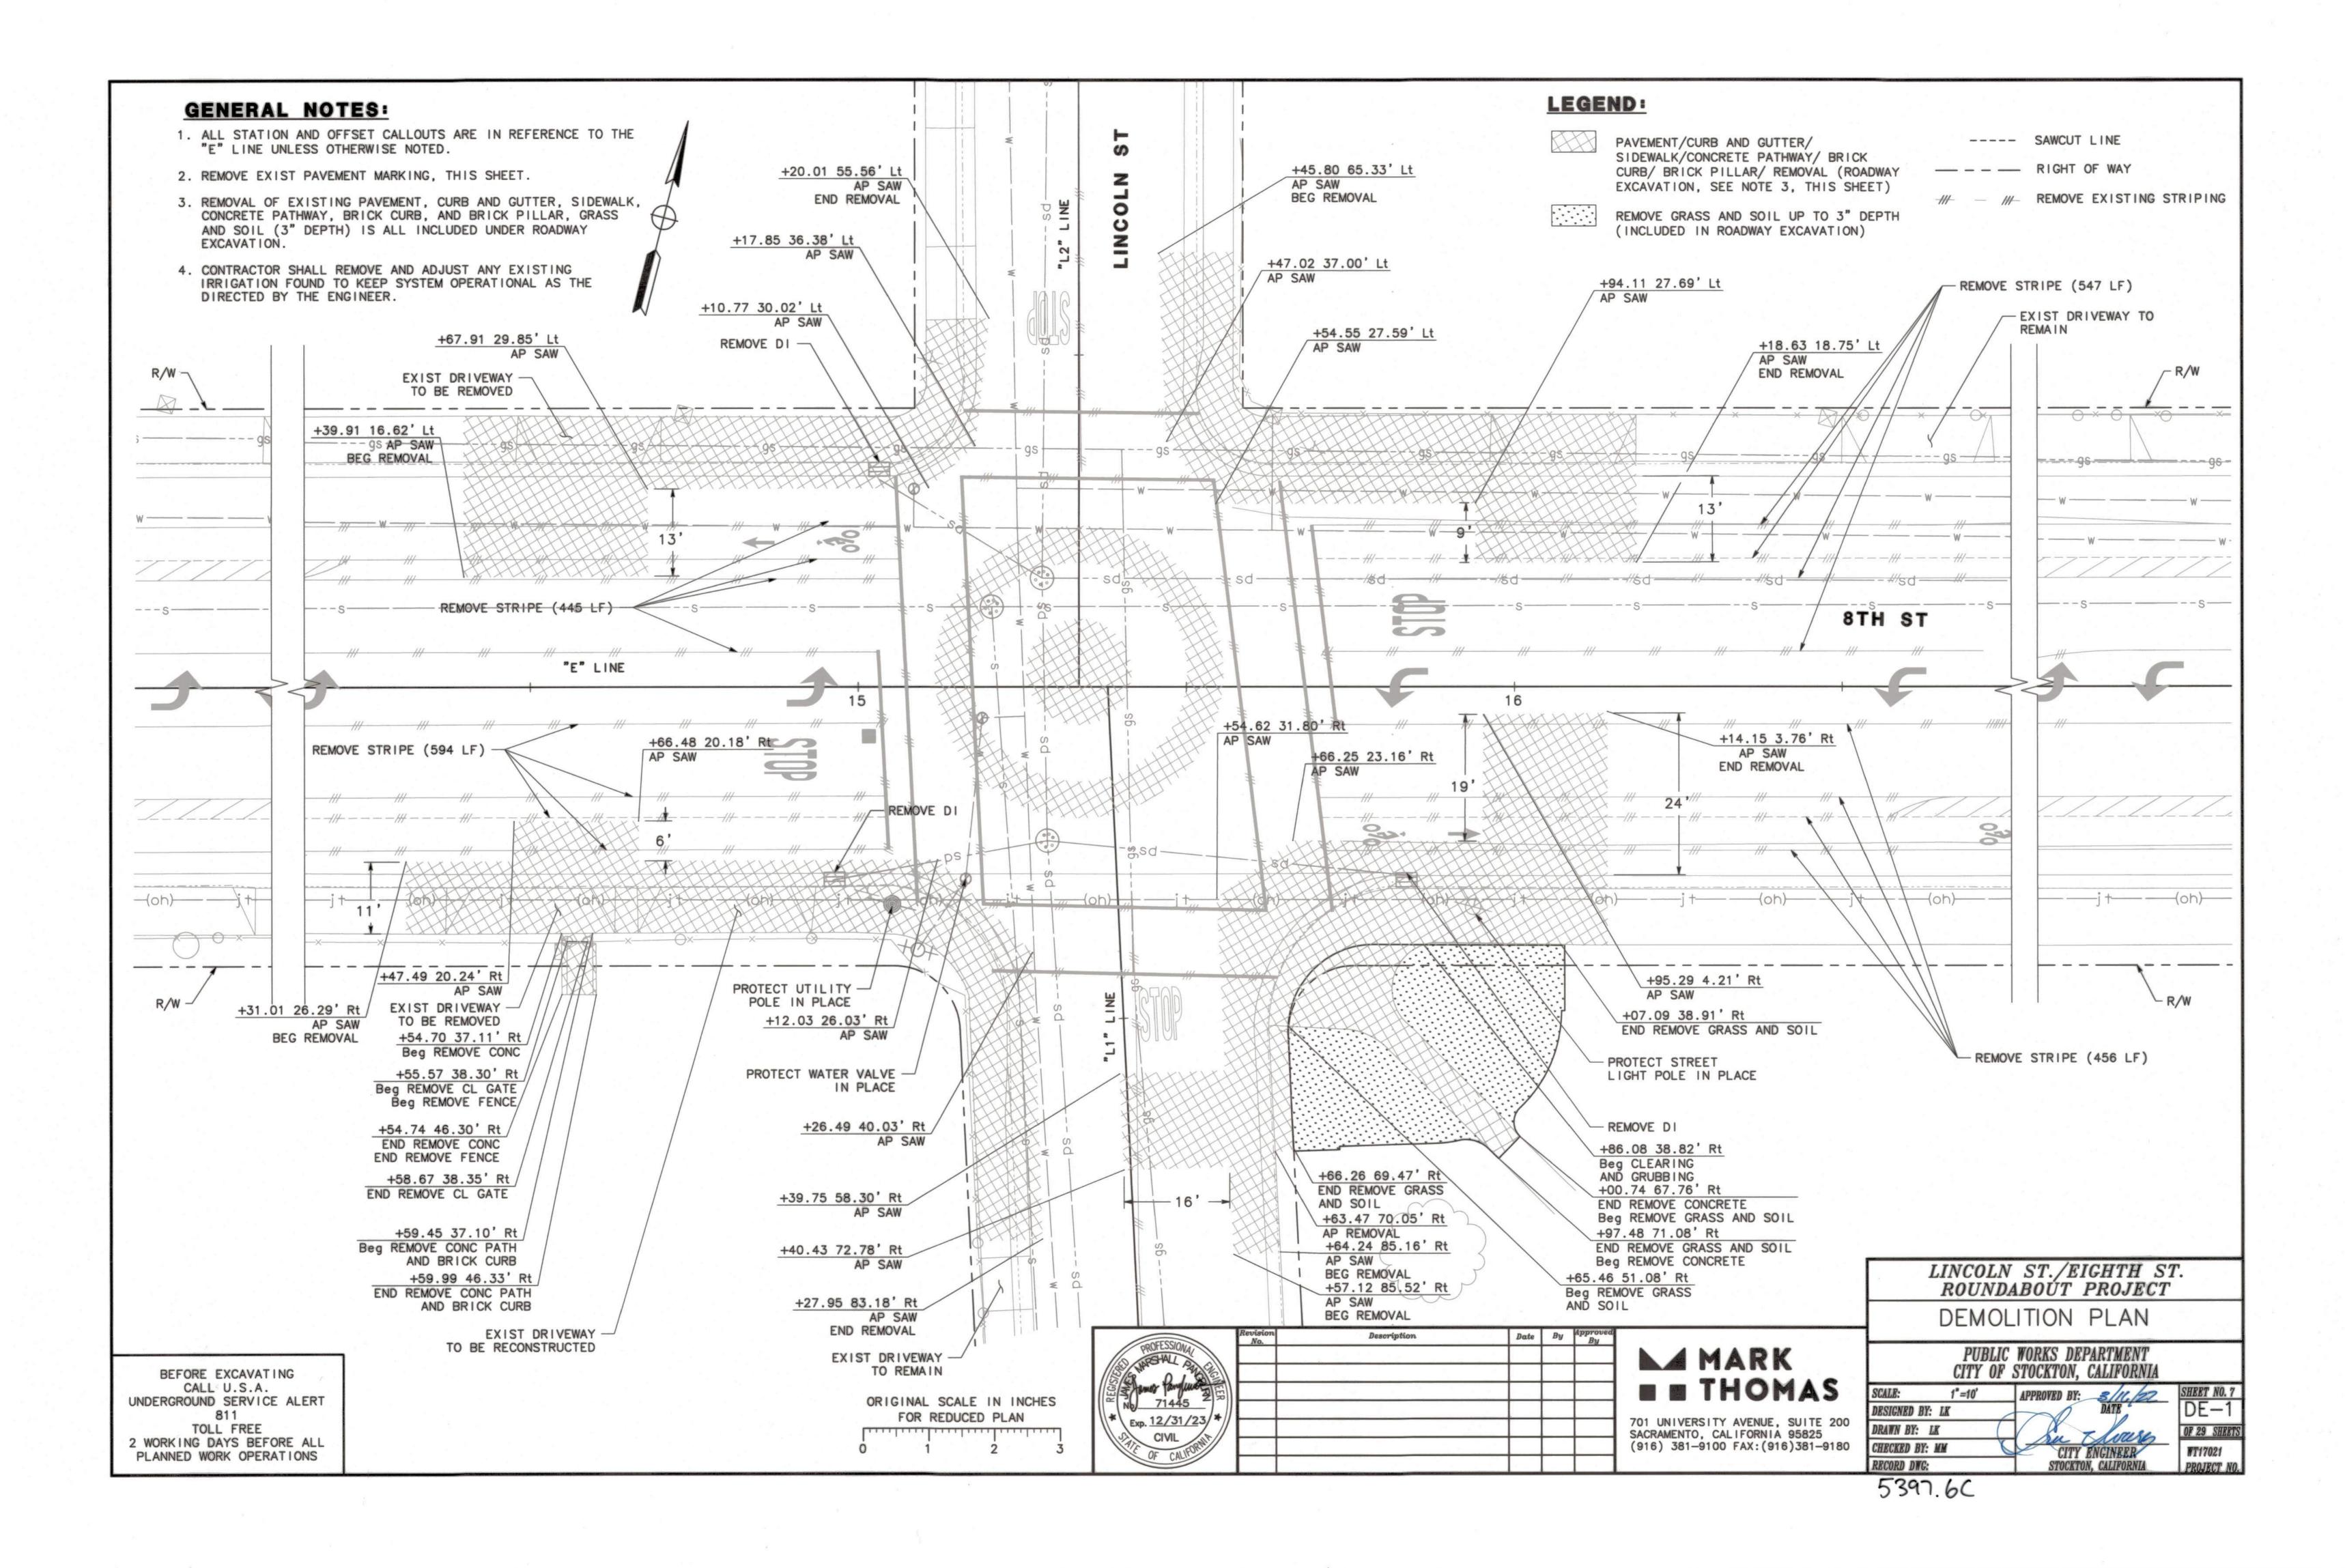

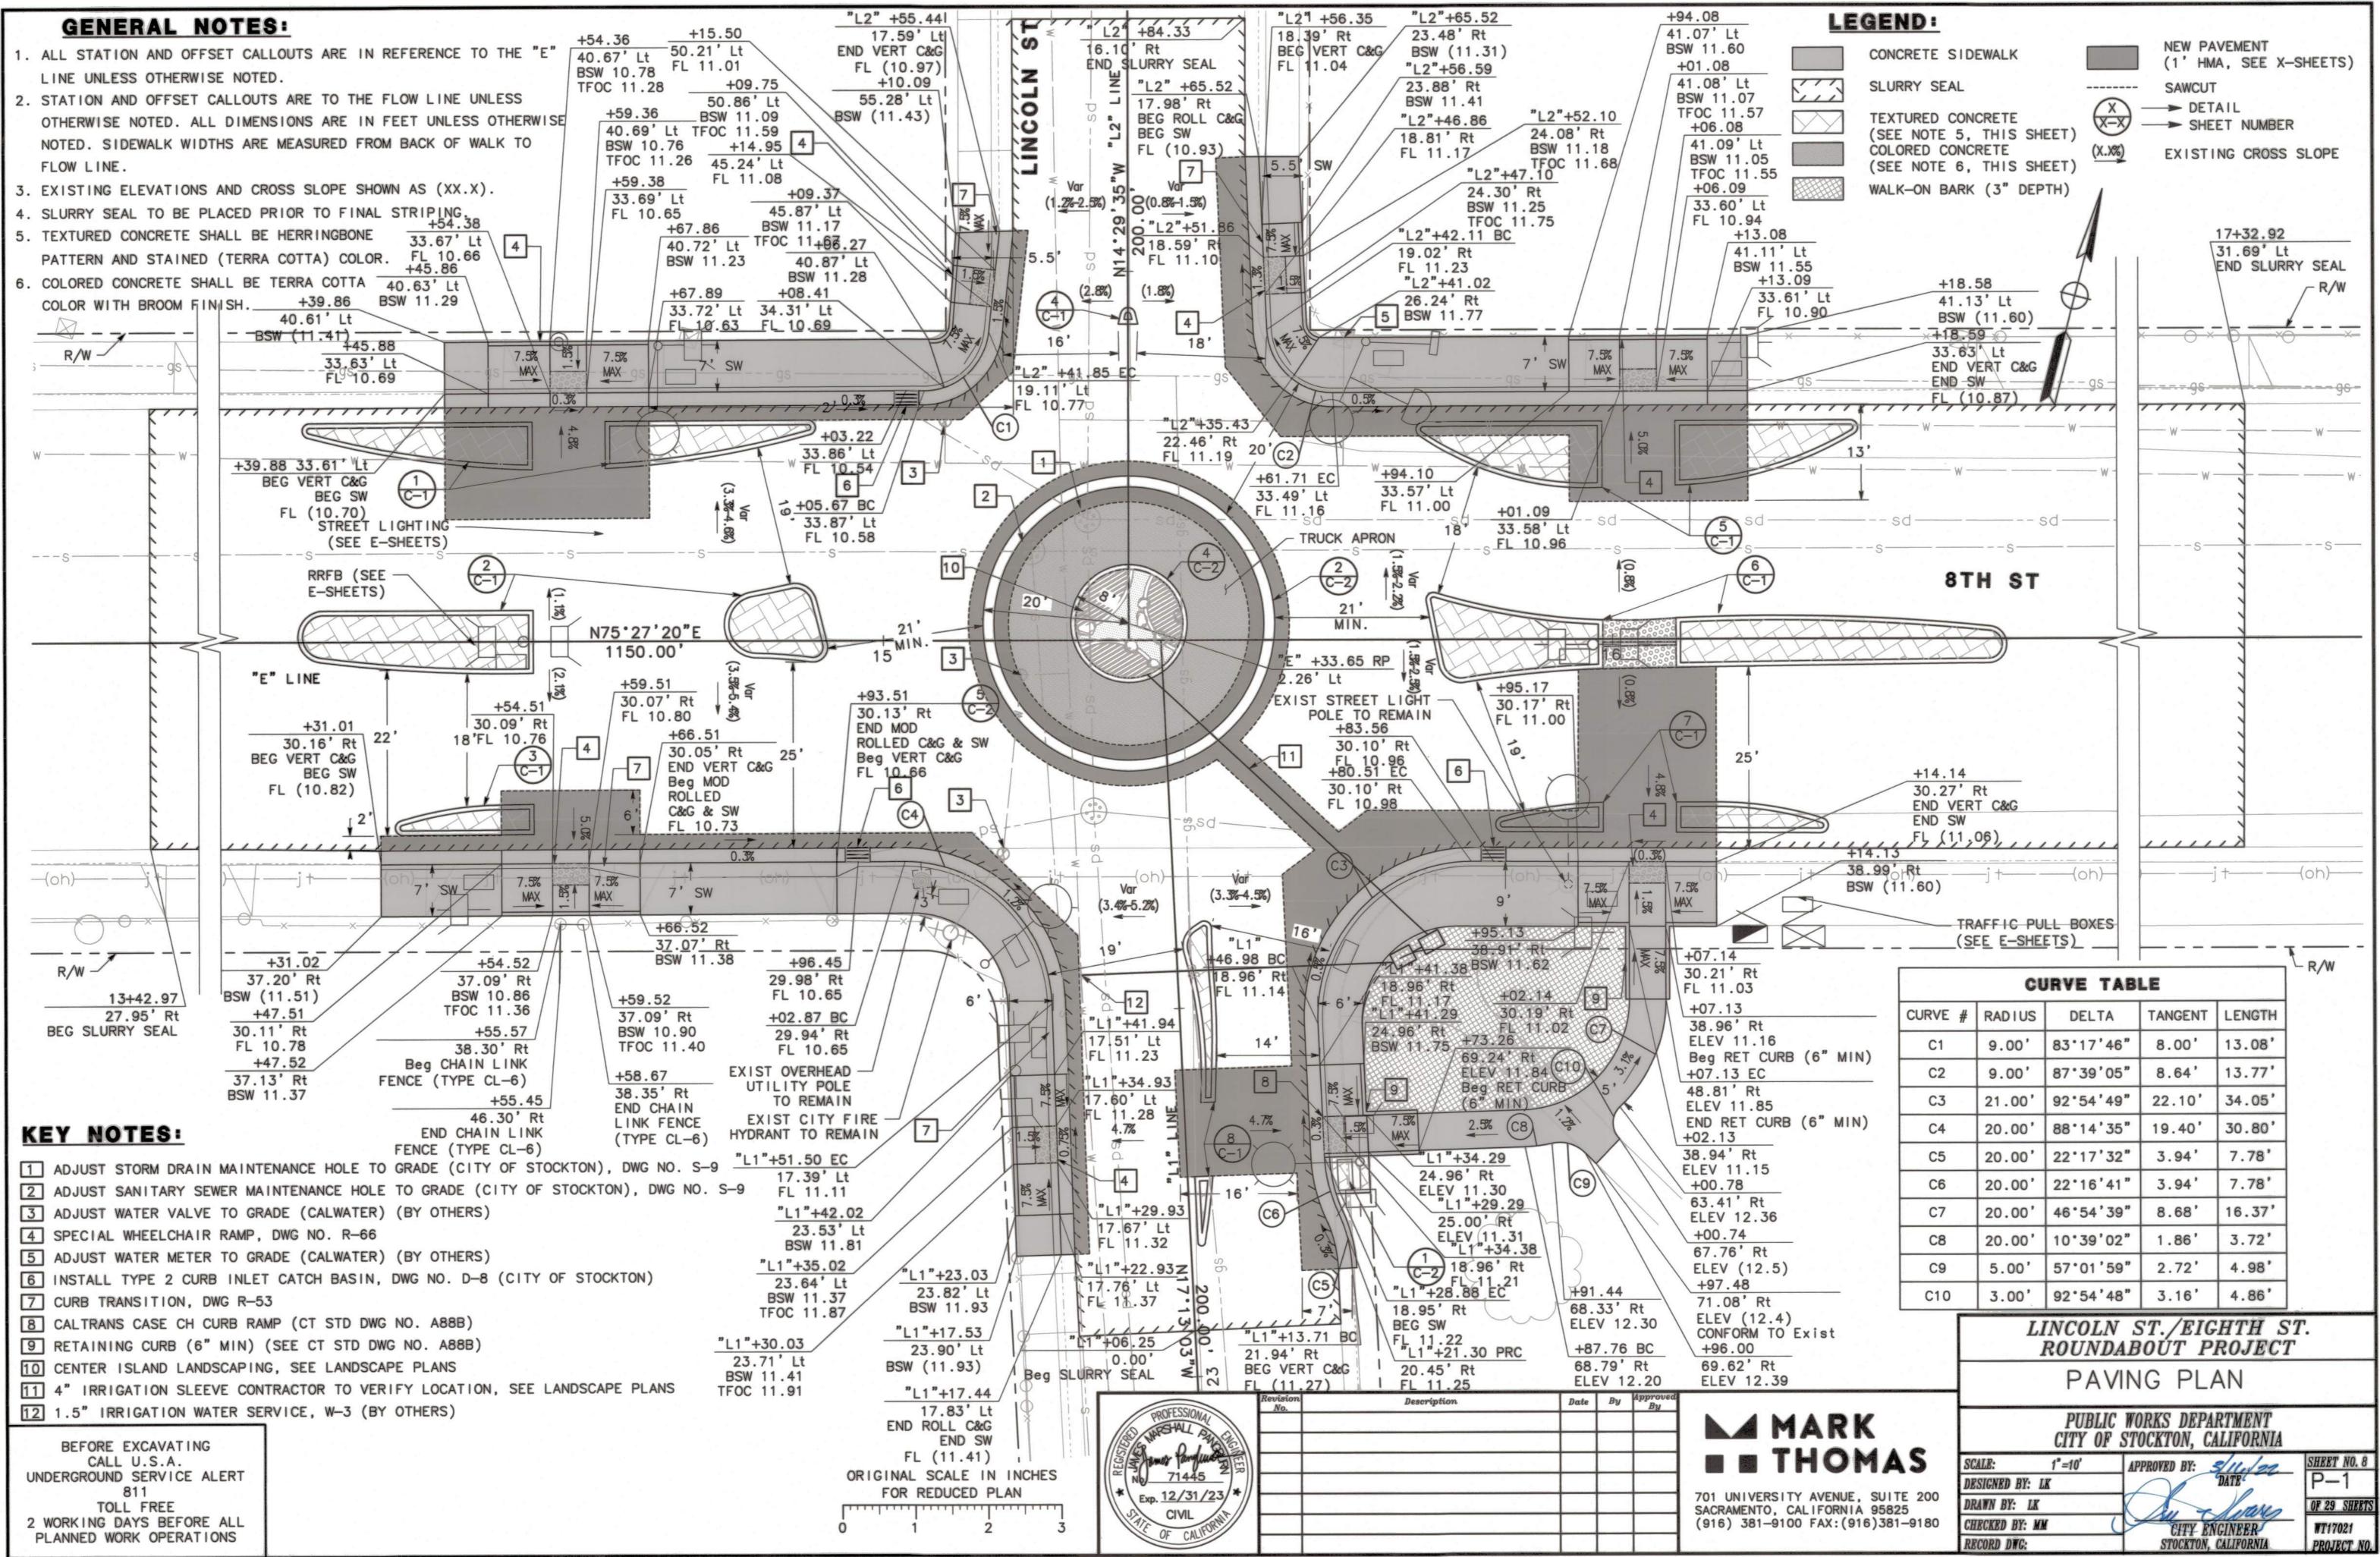



GENERAL NOTES:

- 1. "E" LINE IS IN THE EAST-WEST DIRECTION (SEE SHEET P-1, PAVING PLAN).
- 2. "L1" AND "L2" LINE IS IN THE NORTH-SOUTH DIRECTION (SEE SHEET P-1, PAVING PLAN).


	CURVE TABLE							
CURVE #	RADIUS	DELTA	TANGENT	LENGTH				
C1	3.50'	172°43'14"	55.02'	10.55				
C2	199.00'	8°26'25"	14.68'	29.32'				
C3	4.50'	168°37'44"	45.20'	13.24				
C4	71.00	6°06'43"	3.79'	7.57				
C5	2.00'	111°28'42"	2.94'	3.89'				
C6	3.00'	88°05'51"	2.90'	4.61'				
C7	1.00'	164°03'57"	7.15'	2.86'				
C8	50.00'	15°13'23"	6.68'	13.28'				
C9	1.00'	164°51'19"	7.52'	2.88'				
C10	132.00'	13°33'15"	15.69'	31.23'				
C11	132.00'	12°23'36"	14.33'	28.55				
C12	1.00'	164°51'19"	7.52'	2.88'				
C13	1.00'	118°06'45"	1.67'	2.06'				
C14	3.00'	86°37'38"	2.83'	4.54'				
C15	90.00'	14°51'36"	11.74'	23.34'				
C16	147.58'	7°25'27"	9.57'	19.12'				
C17	287.23'	8°36'58"	21.64'	43.19'				
C18	2.50'	173°35'52"	44.70'	7.57'				
C19	1.00'	145°04'26"	3.18'	2.53'				
C20	40.00'	36°26'16"	13.17'	25.44'				

	CURVE TABLE							
CURVE #	RADIUS	DELTA	TANGENT	LENGTH				
C21	50.00'	28°50'51"	12.86	25.17				
C22	1.00'	149'38'30"	3.69'	2.61'				
C23	1.00'	164°53'14"	7.54'	2.88				
C24	60.00'	13°35'03"	7.15	14.23'				
C25	50.00'	17°12'16"	7.56'	15.01				
C26	1.00'	163°06'06"	6.73'	2.85				
C27	0.50'	168°19'27"	4.89'	1.47				
C28	61.00'	19°22'38"	10.41'	20.63				
C29	99.00'	6°56'19"	6.00'	11.99				
C30	3.00'	72°08'14"	2.19'	3.78				
C31	1.00'	123°55'05"	1.88'	2.16				
C32	1.00'	153°37'34"	4.27'	2.68				
C33	71.00'	5°04'03"	3.14'	6.28				
C34	99.00'	5°18'06"	4.58'	9.16'				

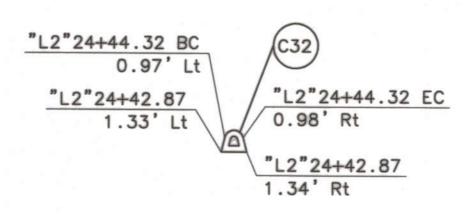


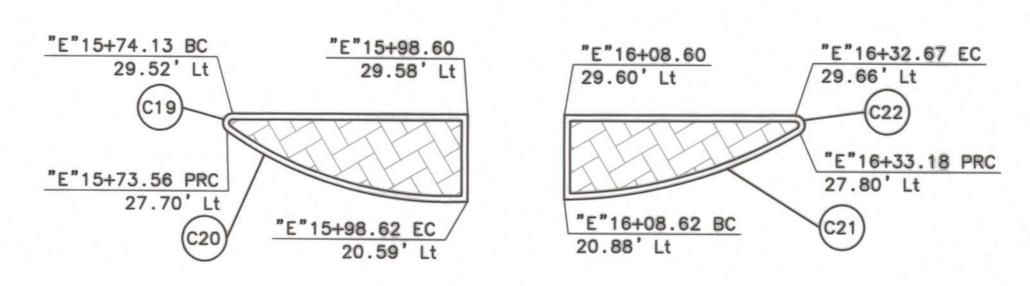


MEDIAN 5 5

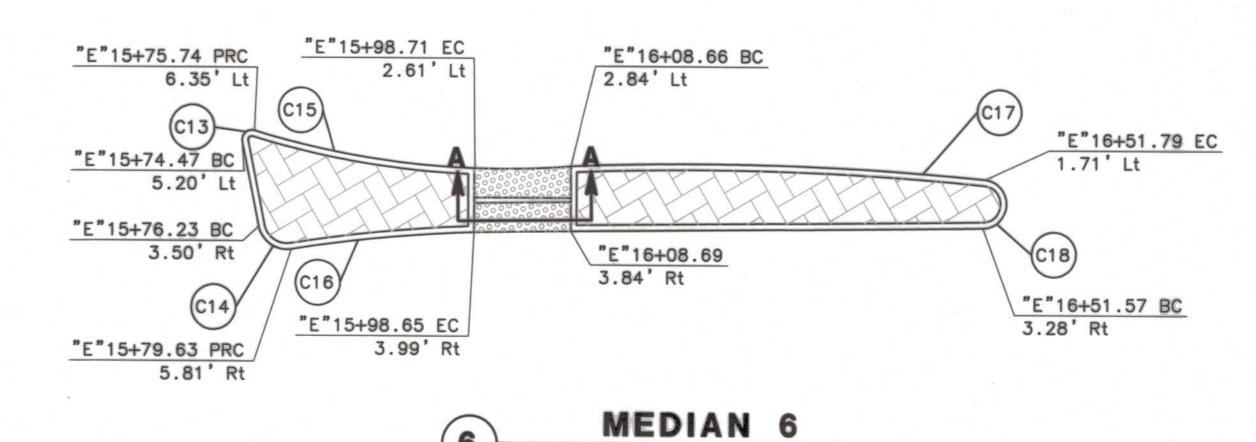


MEDIAN 4

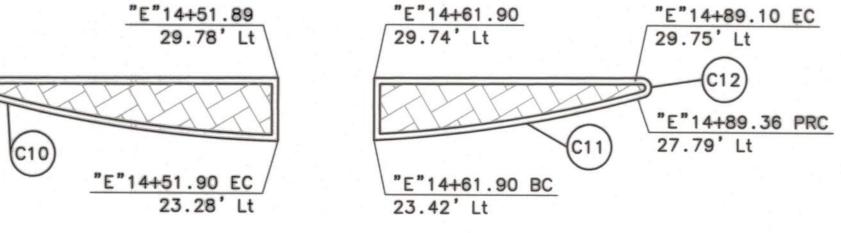

MEDIAN 1

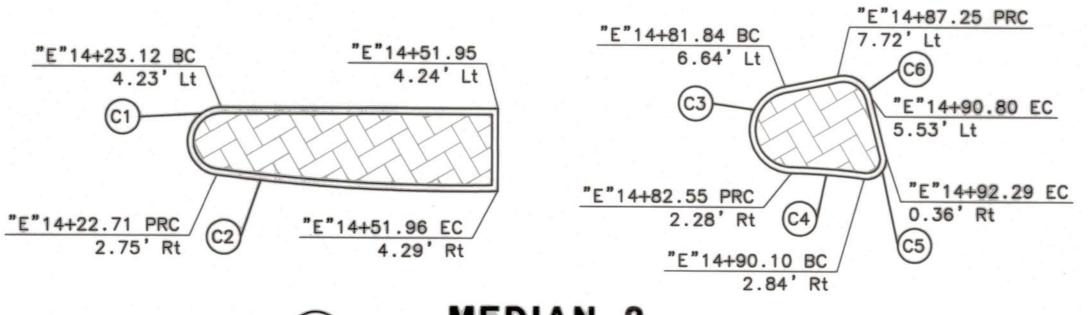

MEDIAN 2 (2

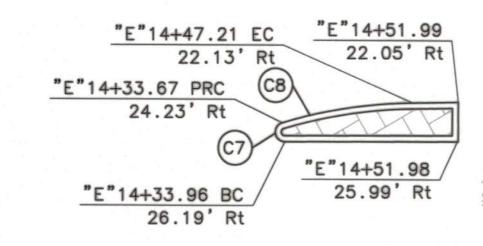


UNDERGROUND SERVICE ALERT TOLL FREE 2 WORKING DAYS BEFORE ALL PLANNED WORK OPERATIONS

BEFORE EXCAVATING CALL U.S.A.

"E"14+21.12 BC

"E"14+20.86 PRC / 27.75' Lt

29.71' Lt

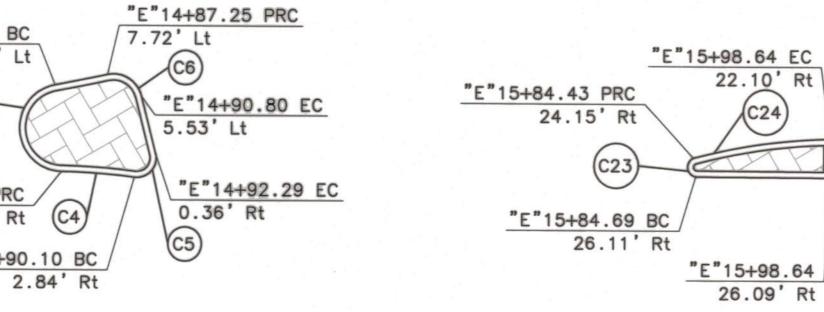

MEDIAN 7

Manus Paralluse 2


Exp. 12/31/23/*

CIVIL

Description

4 4 4

MEDIAN CURB — — TYPE A3

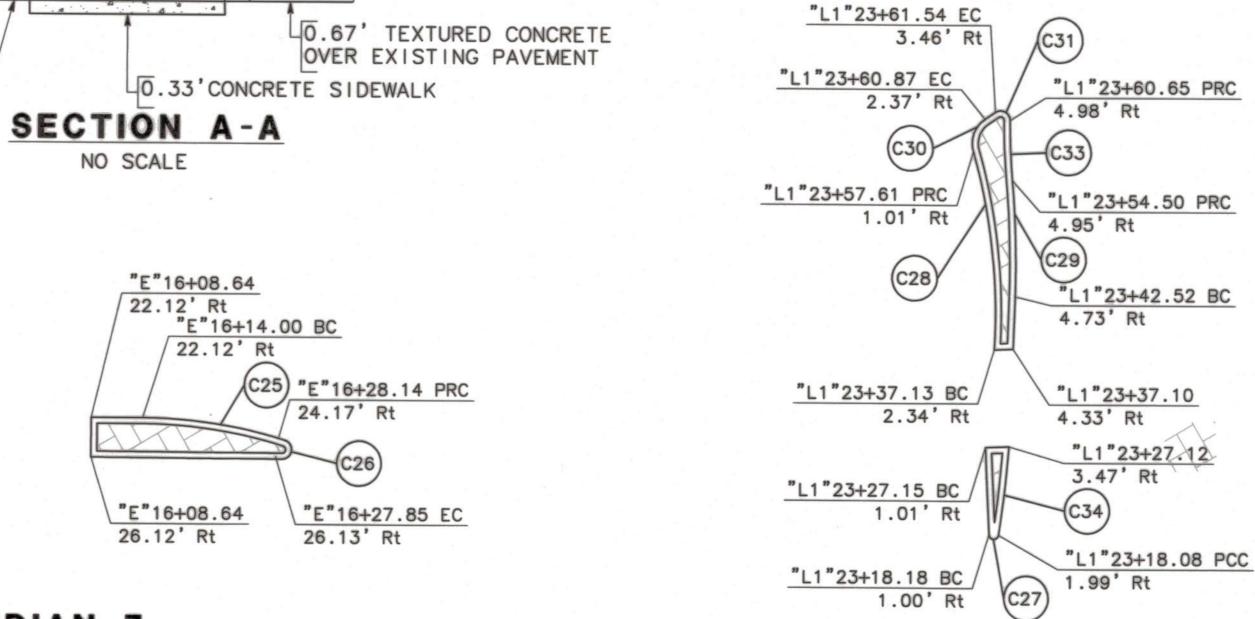

Date By Approve MARK **THOMAS**

701 UNIVERSITY AVENUE, SUITE 200 SACRAMENTO, CALIFORNIA 95825 (916) 381-9100 FAX: (916)381-9180

LINCOLN ST./EIGHTH ST. ROUNDABOÚT PROJECT CONSTRUCTION DETAILS

PUBLIC WORKS DEPARTMENT CITY OF STOCKTON, CALIFORNIA 1"=10"

SCALE: DESIGNED BY: LK DRAWN BY: LK OF 29 SHEET CHECKED BY: MM RECORD DWG: STOCKTON, CALIFORNIA


5397.8C


MEDIAN 8


 $(\mathbf{3})$

MEDIAN 3

ORIGINAL SCALE IN INCHES FOR REDUCED PLAN

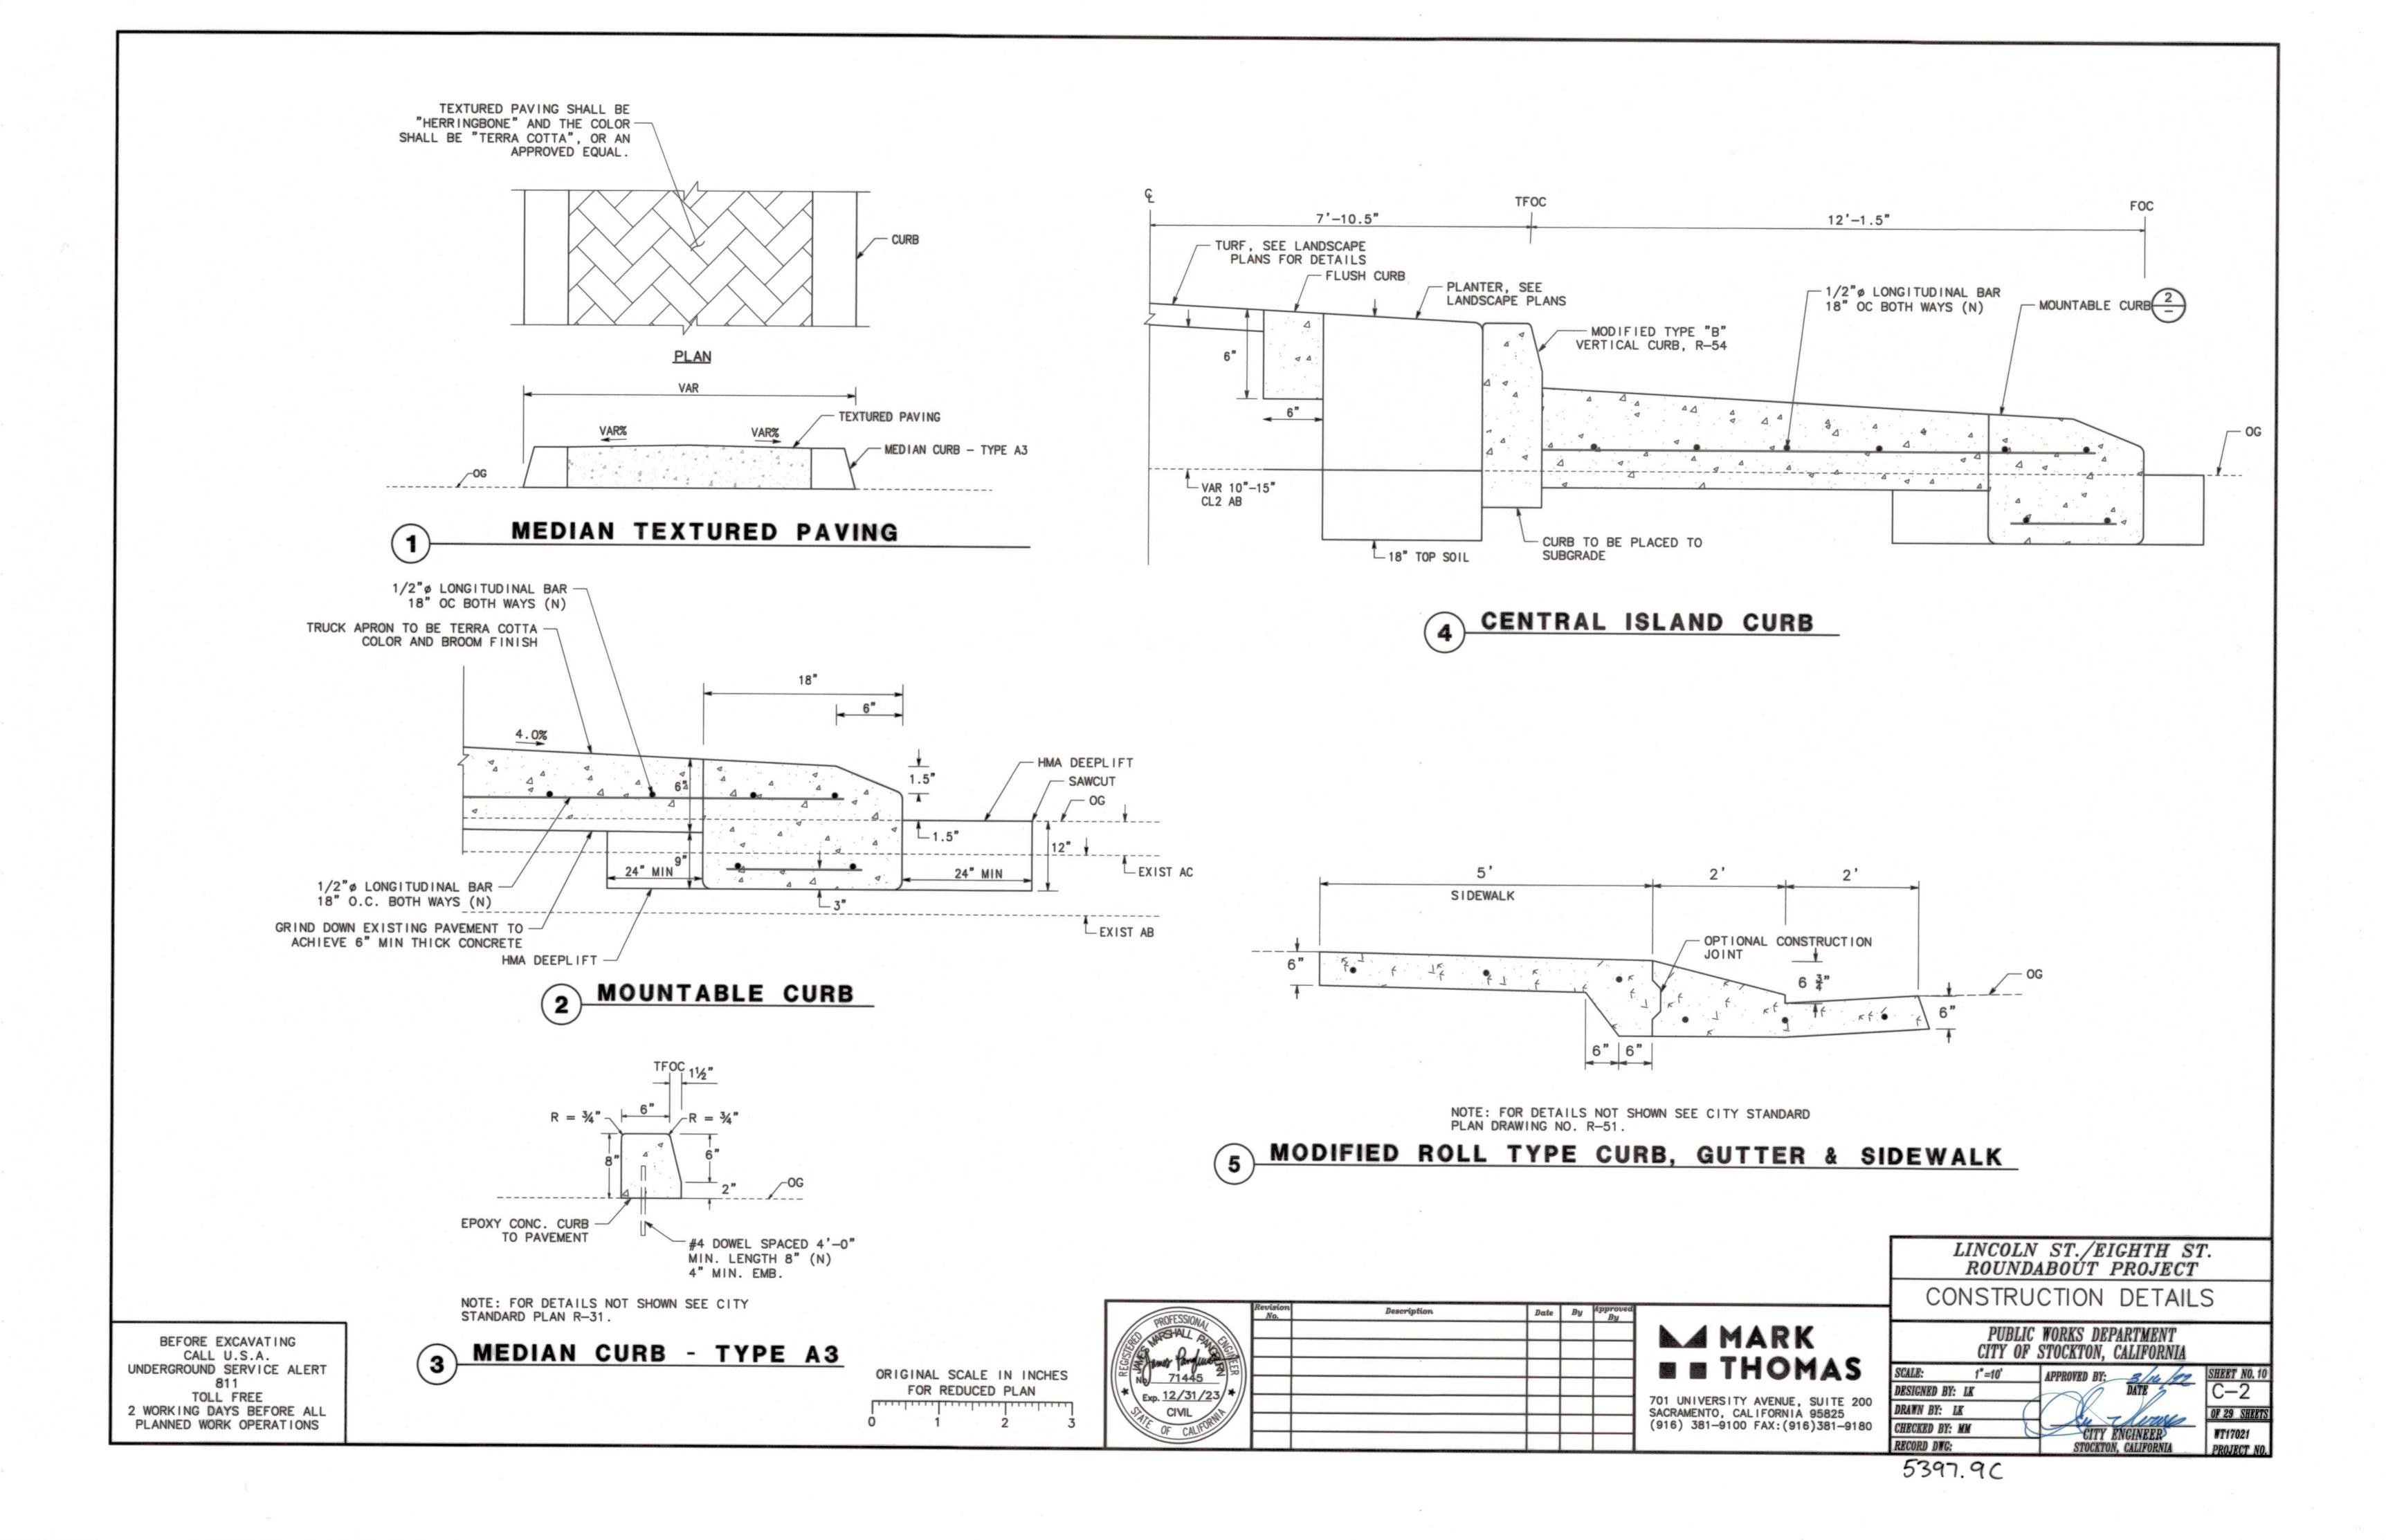


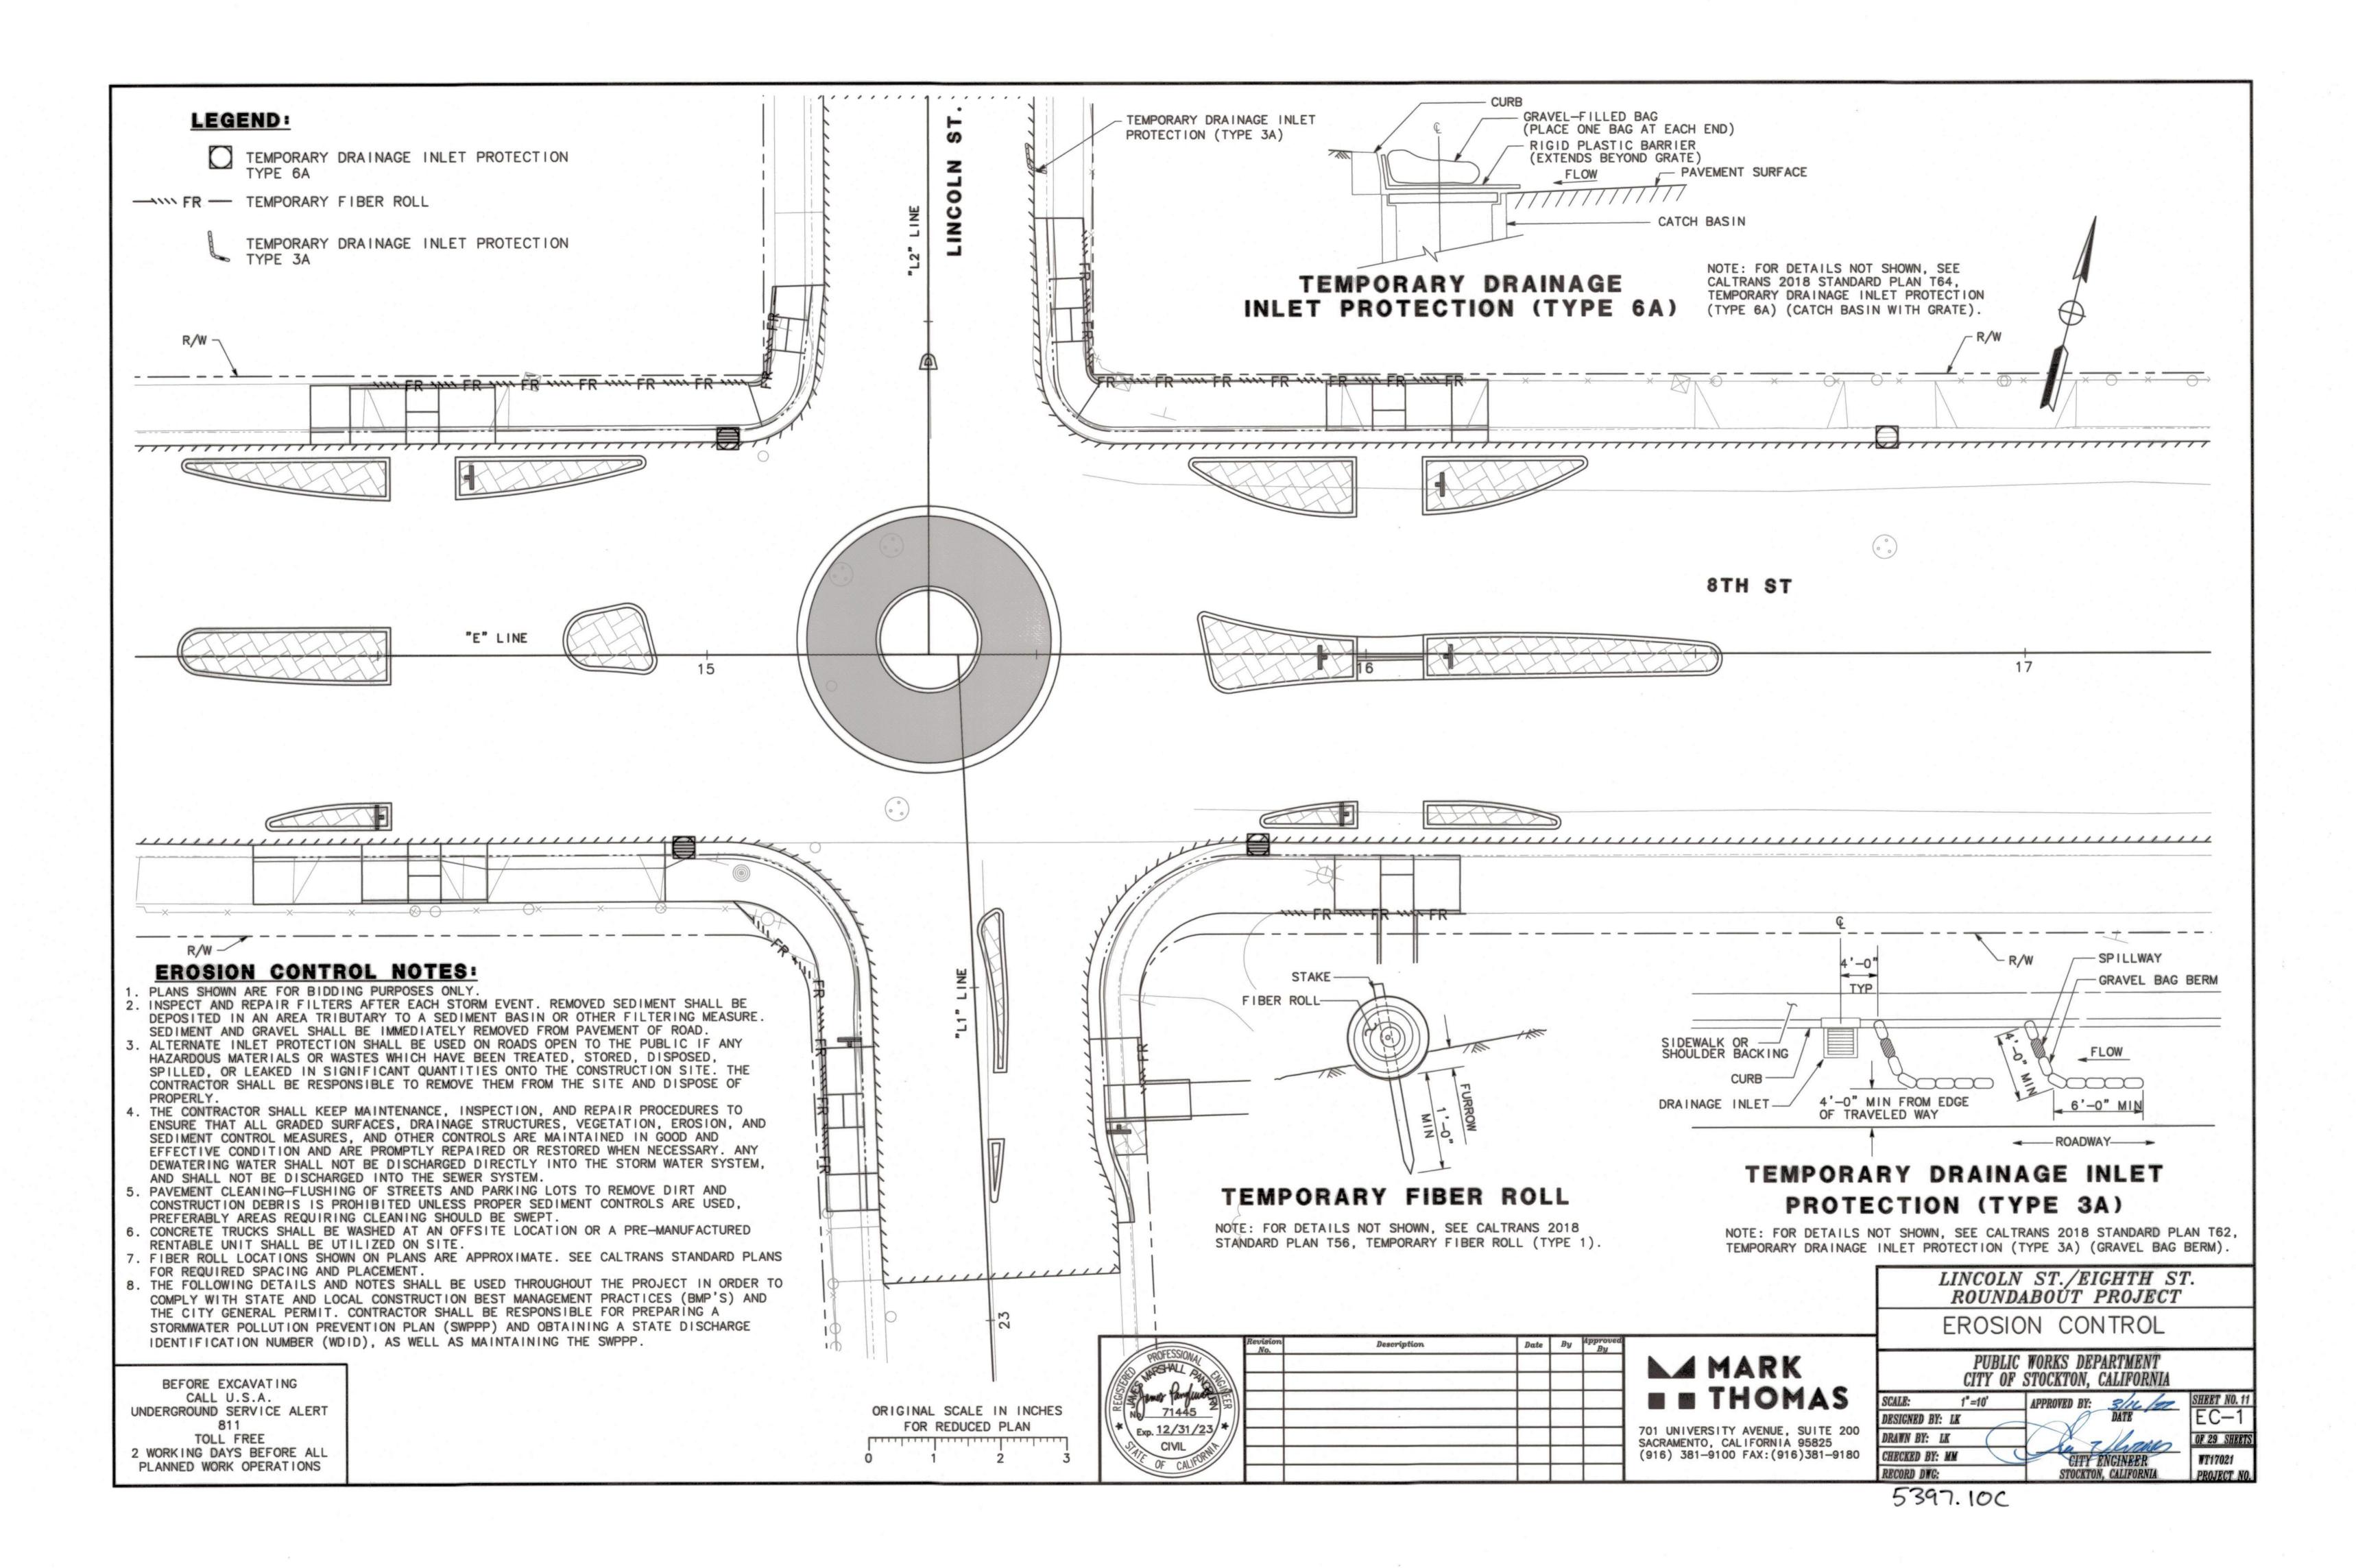

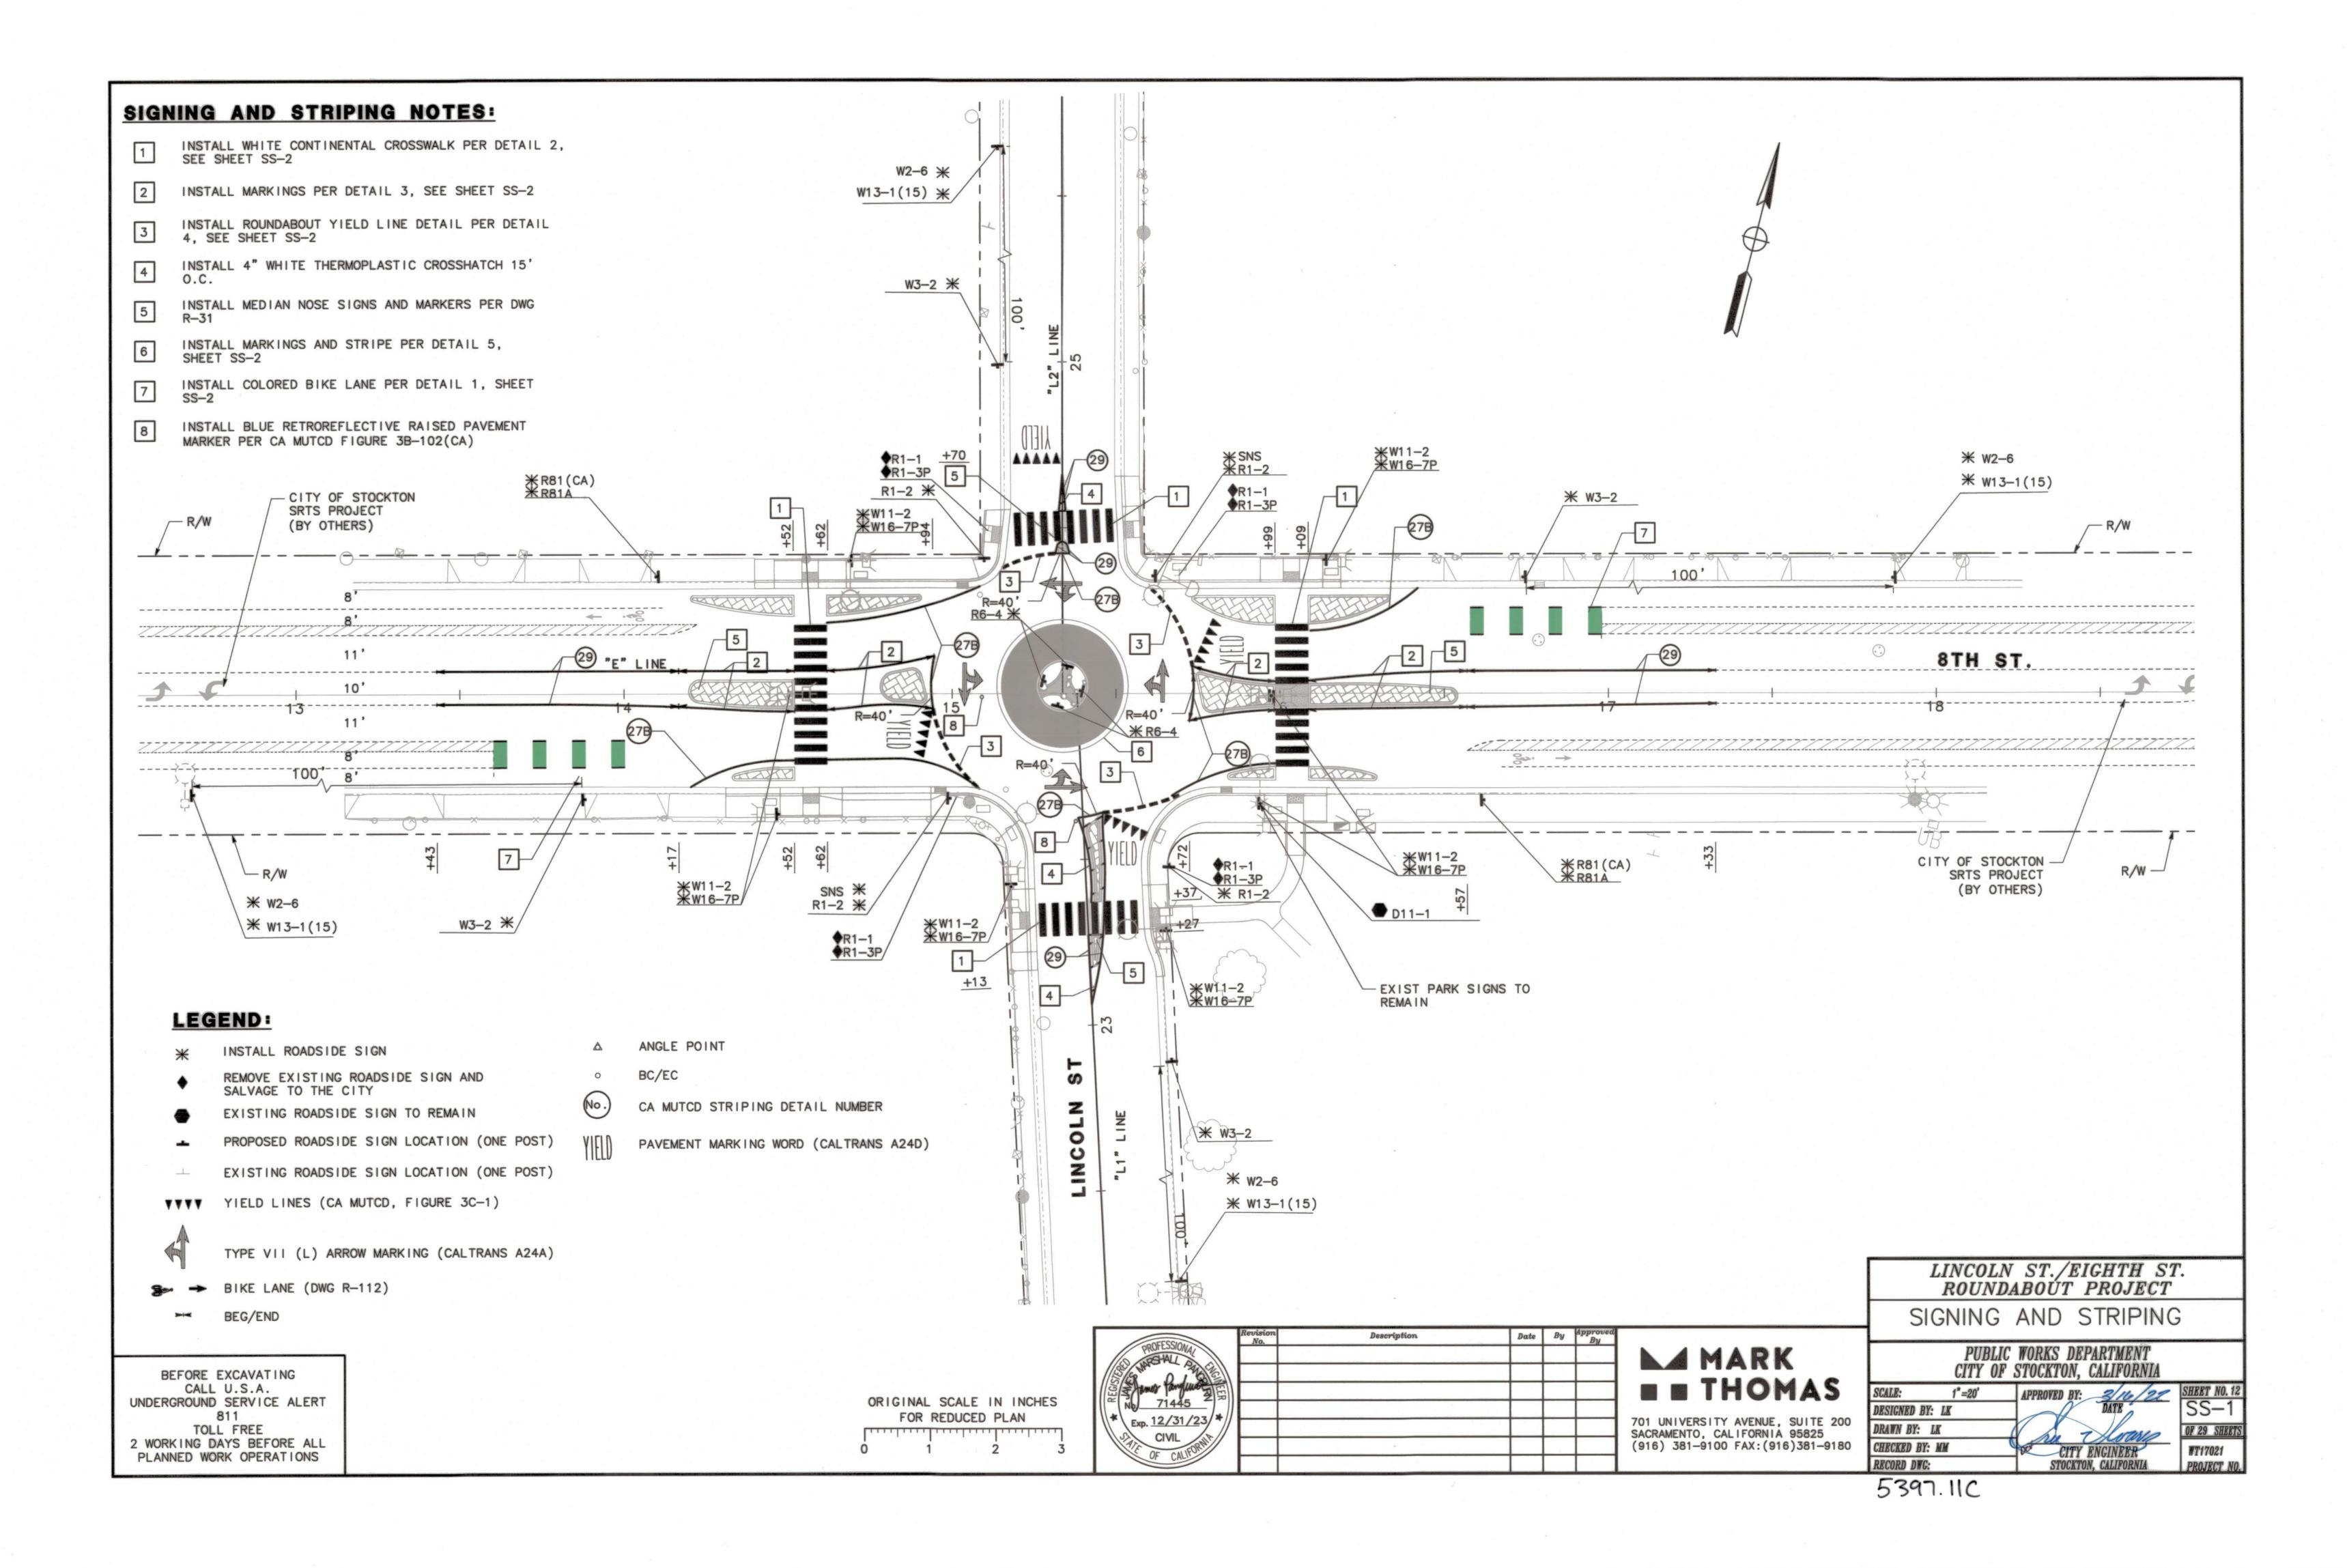

GENERAL NOTES:


- ALL WORK SHALL BE DONE IN ACCORDANCE WITH THE LATEST EDITIONS OF THE CITY OF STOCKTON STANDARD PLANS AND SPECIFICATIONS, CALTRANS STANDARD PLANS AND SPECIFICATIONS DATED MAY 2018, LATEST EDITIONS OF THE 2014 CA MUTCD, SIGN SPECIFICATIONS AND THE SPECIAL PROVISIONS.
- 2. ALL STRIPING SHALL BE SPRAYABLE THERMOPLASTIC AND APPLIED PER CITY OF STOCKTON STANDARDS. STRIPING SHALL BE CAT—TRACKED AND APPROVED BY THE CITY TRAFFIC ENGINEER PRIOR TO FINAL APPLICATIONS OF SPRAYABLE THERMOPLASTIC/MARKERS. CONTRACTOR SHALL NOTIFY CITY TRAFFIC ENGINEER NOT LATER THAN TWO WORKING DAYS PRIOR TO FINAL APPLICATION.
- 3. ALL CROSSWALKS, LIMIT LINES AND PAVEMENT MARKINGS SHALL BE THERMOPLASTIC.
- 4. EXACT LOCATIONS AND POSITIONS OF ROADSIDE SIGNS SHALL BE CONFIRMED IN THE FIELD BY THE ENGINEER.
- 5. ALL OUTSIDE LANE DIMENSIONS ARE MEASURED FROM THE LIP OF GUTTER.
- 6. CONTRACTOR SHALL BE RESPONSIBLE FOR REMOVING EXISTING STRIPING THAT CONFLICTS WITH NEW STRIPING.
- 7. ALL NEW ROADSIDE SIGNS SHALL BE INSTALLED ON "UNISTRUT TYPE" POSTS IN ACCORDANCE WITH CITY STD DWG NO. R-109.
- 8. FUNDING SIGN LOCATION TO BE COORDINATED WITH THE CITY ENGINEER.

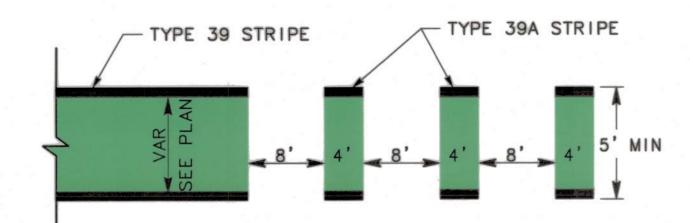

NOTE:
SPECIAL BIKE LANE TREATMENT (INCLUDING ALL
MARKINGS ASSOCIATED WITH BIKE LANE STRIPING) IS
NOT THERMOPLASTIC AND MUST BE PLACED IN
ACCORDANCE WITH SECTION 84 (COLOR PAVEMENTS FOR
BIKE LANES) OF THE PROJECTS SPECIFICATIONS.

COLORED PAVEMENT FOR BIKE LANES (GREEN)

NO SCALE

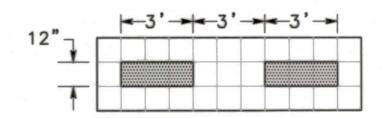


ROUNDABOUT YIELD LINE DETAIL

NO SCALE

INSTALL TWO REFLECTIVE TYPE G MARKERS IN FRONT OF EACH LADDER STRIPE ON APPROACH SIDE OF THE CROSSWALK FROM CENTERLINE TO LIP. NO MARKERS ARE TO BE INSTALLED IN BIKE LANES DIRECTION OF TRAVEL NOTE: SPACES BETWEEN MARKINGS MUST BE PLACED IN WHEEL TRACKS OF EACH LANE.

CONTINENTAL CROSSWALK DETAIL NO SCALE

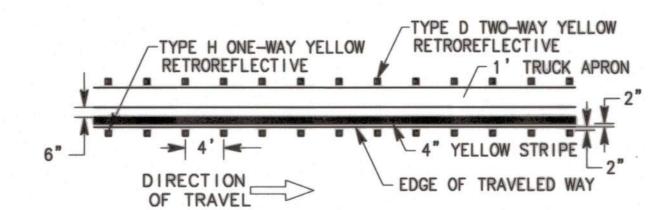

DETAIL 25(M) - ROUNDABOUT MODIFIED

NO SCALE

LEGEND:

- * INSTALL ROADSIDE SIGN
- REMOVE EXISTING ROADSIDE SIGN AND SALVAGE TO THE CITY
- EXISTING ROADSIDE SIGN TO REMAIN
- PROPOSED ROADSIDE SIGN LOCATION (ONE POST)
- EXISTING ROADSIDE SIGN LOCATION (ONE POST)
- YYYY YIELD LINES (CA MUTCD, FIGURE 3C-1)




TYPE VII (L) ARROW MARKING (CALTRANS A24A)

> → BIKE LANE (DWG R-112)

- ₩ BEG/END
- A ANGLE POINT
- BC/EC
- CA MUTCO STRIPING DETAIL NUMBER



PAVEMENT MARKING WORD (CALTRANS A24D)

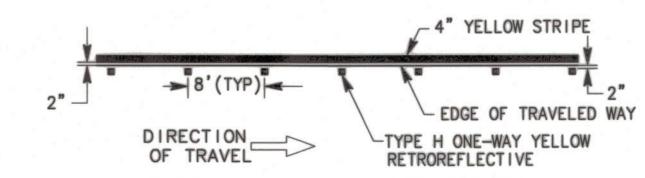

DETAIL 25A(M) - MODIFIED

NO SCALE

6'

CITY OF Your Tax Dollare U.S. Department of Transportation
AT WORK Federal Highway Administration

Lincoln Street and 8th Street
Roundabout
YEAR OF COMPLETION: 2021

FHWA'S Congestion Mitigation and Air Quality
(CMAQ) Improvement Program


FOR INFORMATION CALL:
(209) 937–8411

NOTE:
PROJECT INFORMATION SIGN LOCATION TO BE COORDINATED WITH CITY ENGINEER.

PROJECT INFORMATION SIGN

NO SCALE

ORIGINAL SCALE IN INCHES
FOR REDUCED PLAN

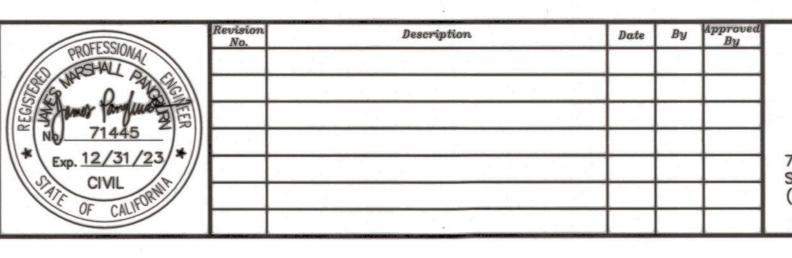

MARK
THOMAS

701 UNIVERSITY AVENUE, SUITE 200 SACRAMENTO, CALIFORNIA 95825 (916) 381-9100 FAX: (916) 381-9180 LINCOLN ST./EIGHTH ST.
ROUNDABOUT PROJECT

SIGNING AND STRIPING

PUBLIC WORKS DEPARTMENT CITY OF STOCKTON, CALIFORNIA

OF 29 SHEET

WT17021

SCALE: 1"=10' APPROVED BY: 3/L/2

DESIGNED BY: LK

DRAWN BY: LK

CHECKED BY: MM


RECORD DWG: STOCKTON, CALIFORNIA


5397.12C


BEFORE EXCAVATING
CALL U.S.A.
UNDERGROUND SERVICE ALERT
811
TOLL FREE
2 WORKING DAYS BEFORE ALL

PLANNED WORK OPERATIONS

4

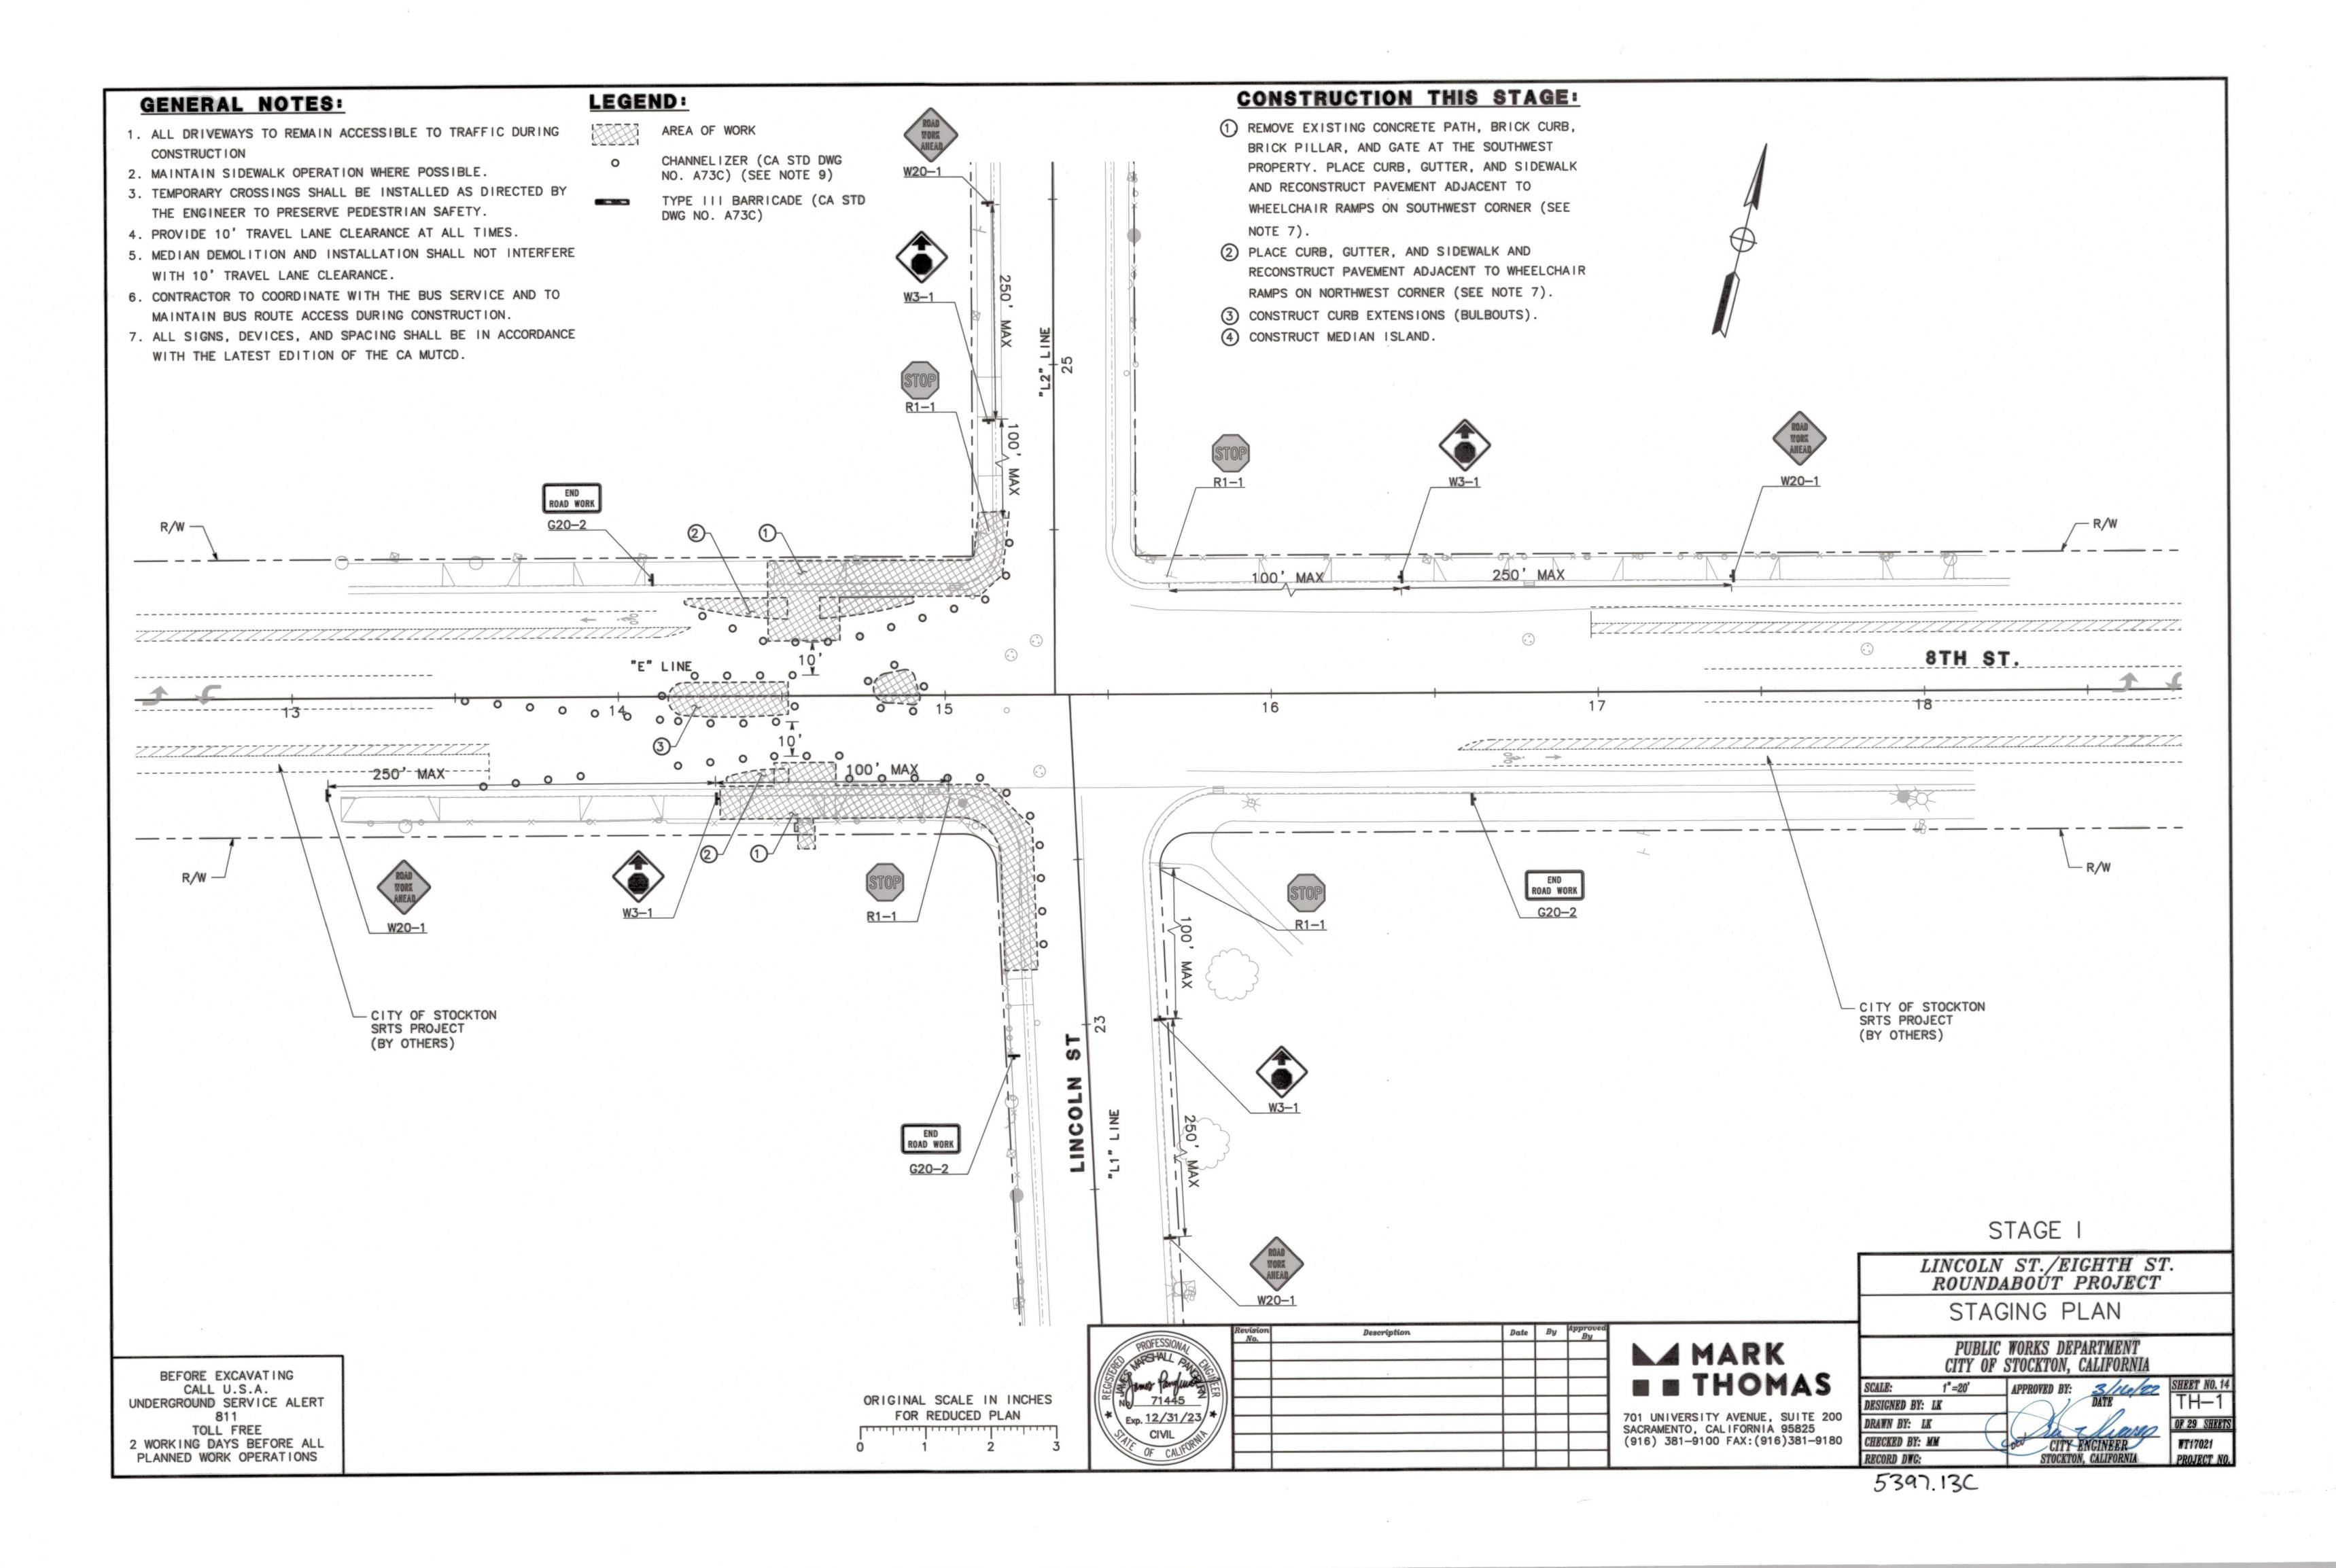

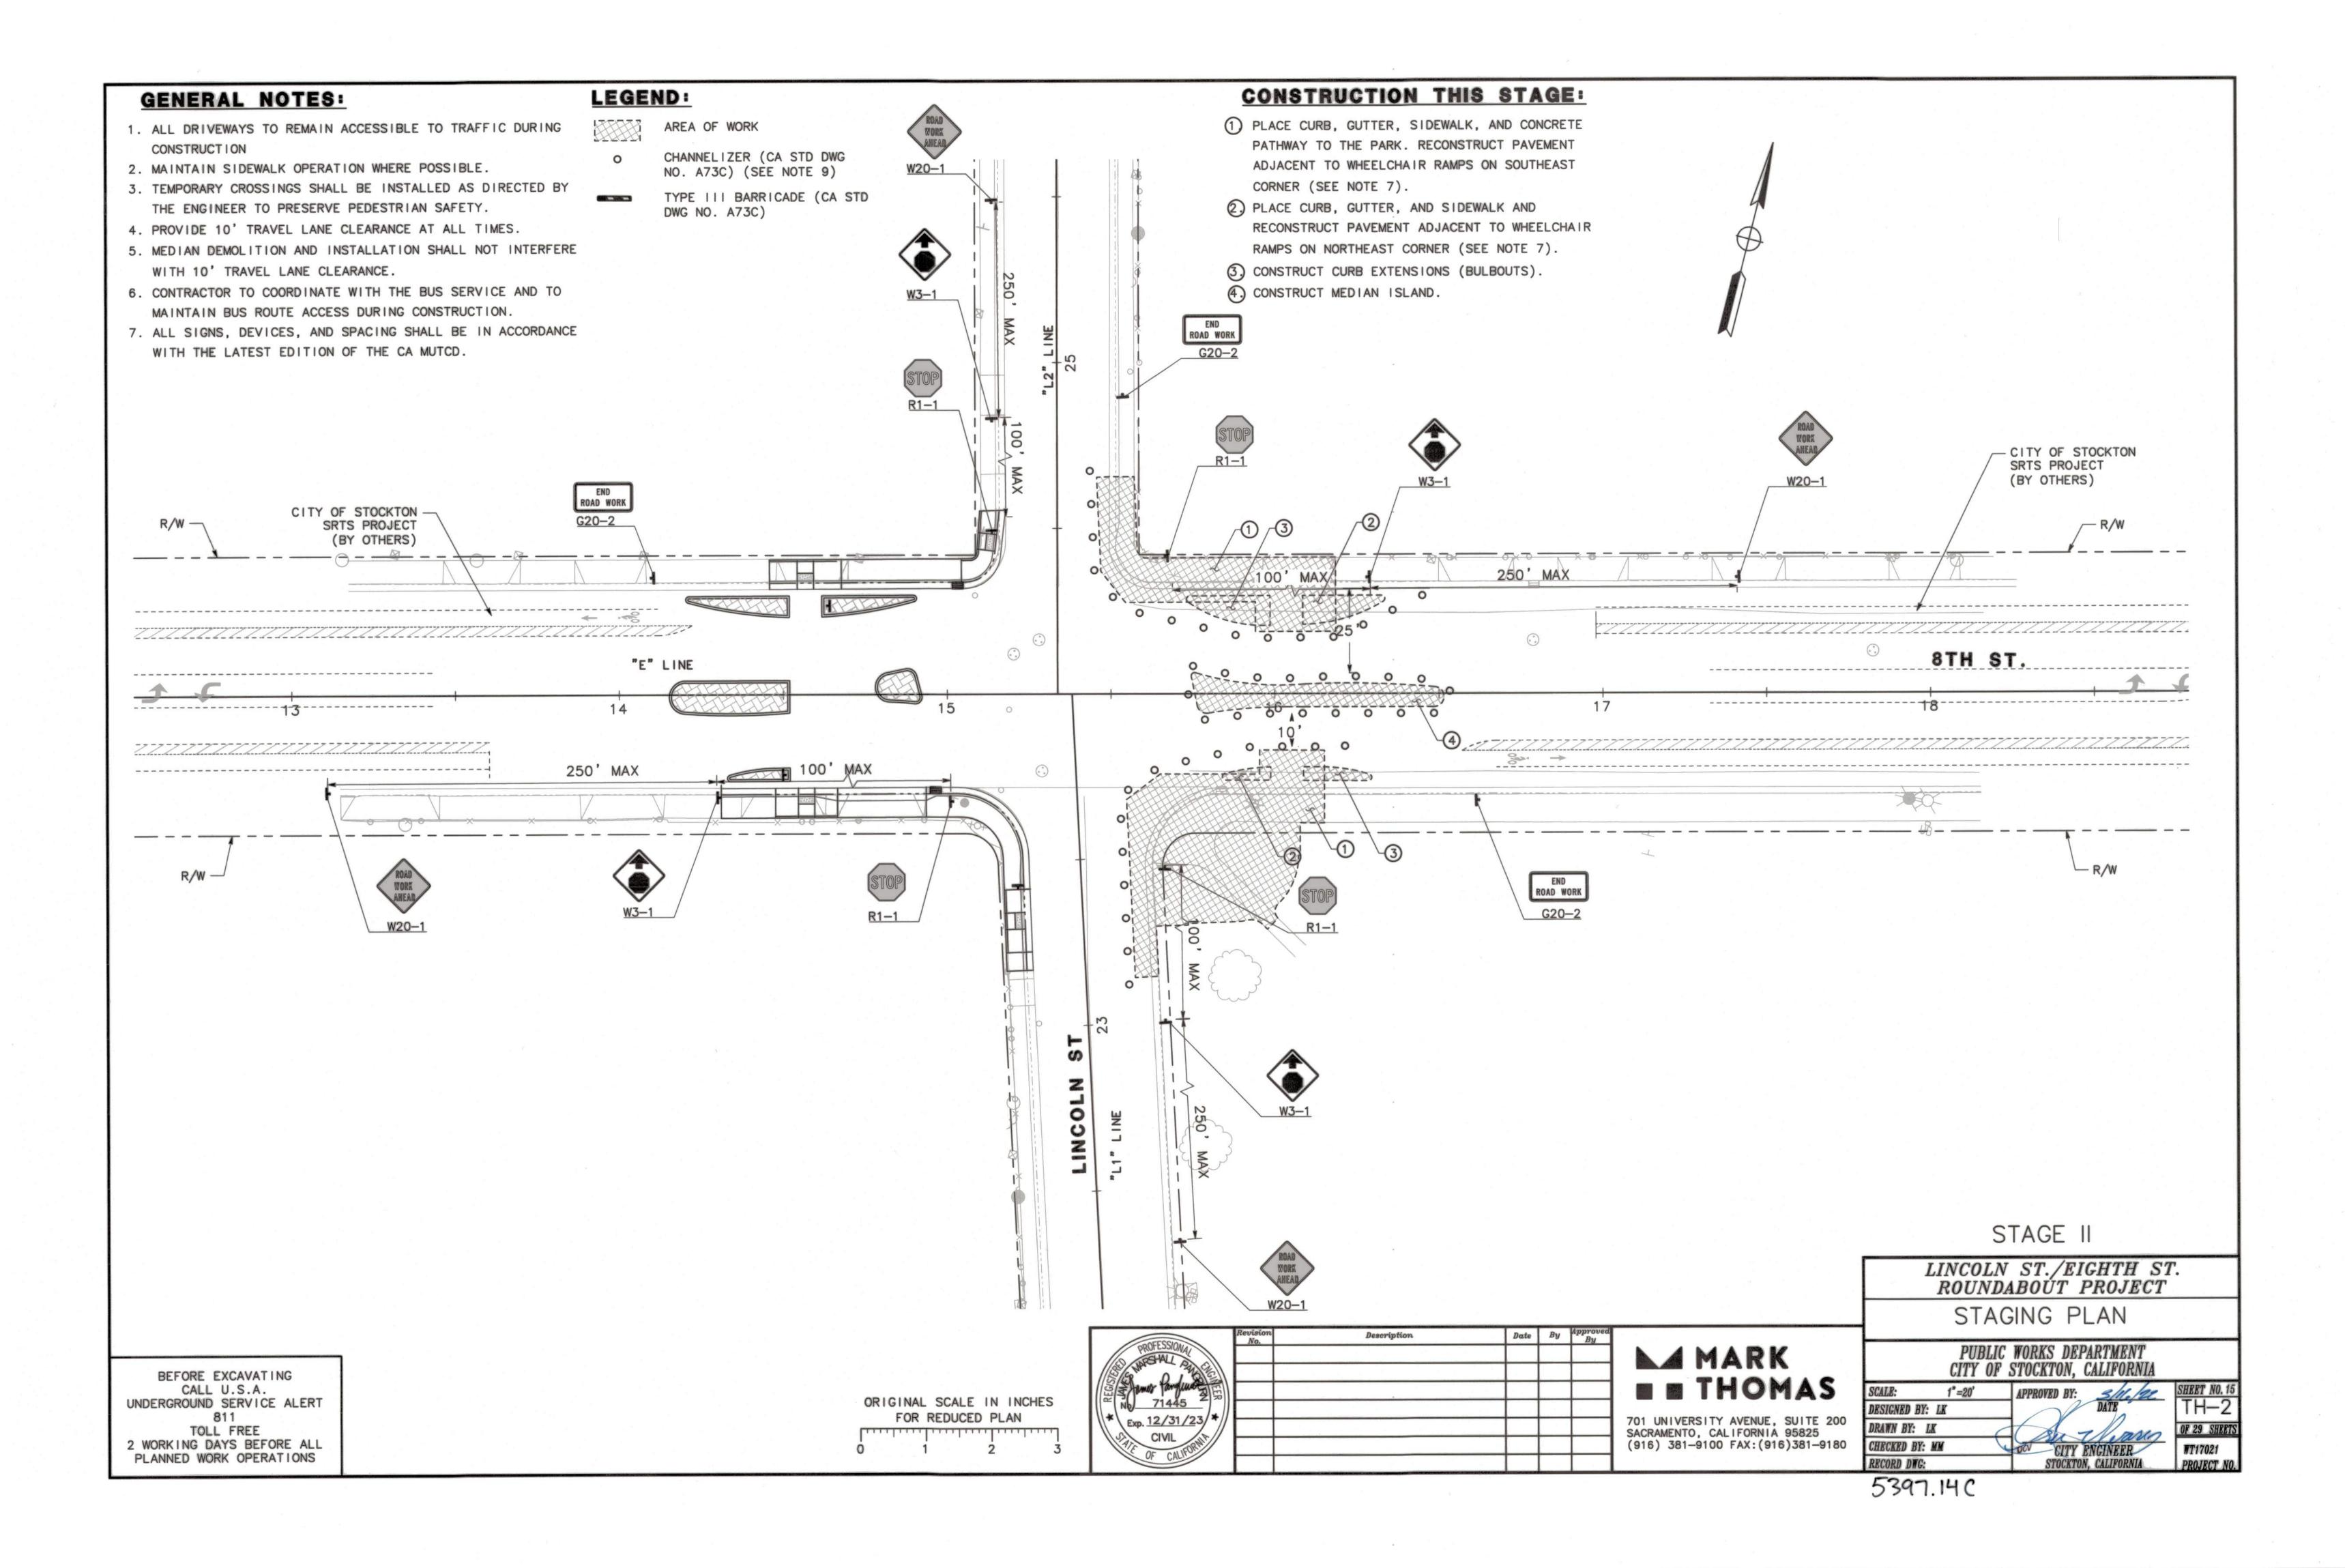

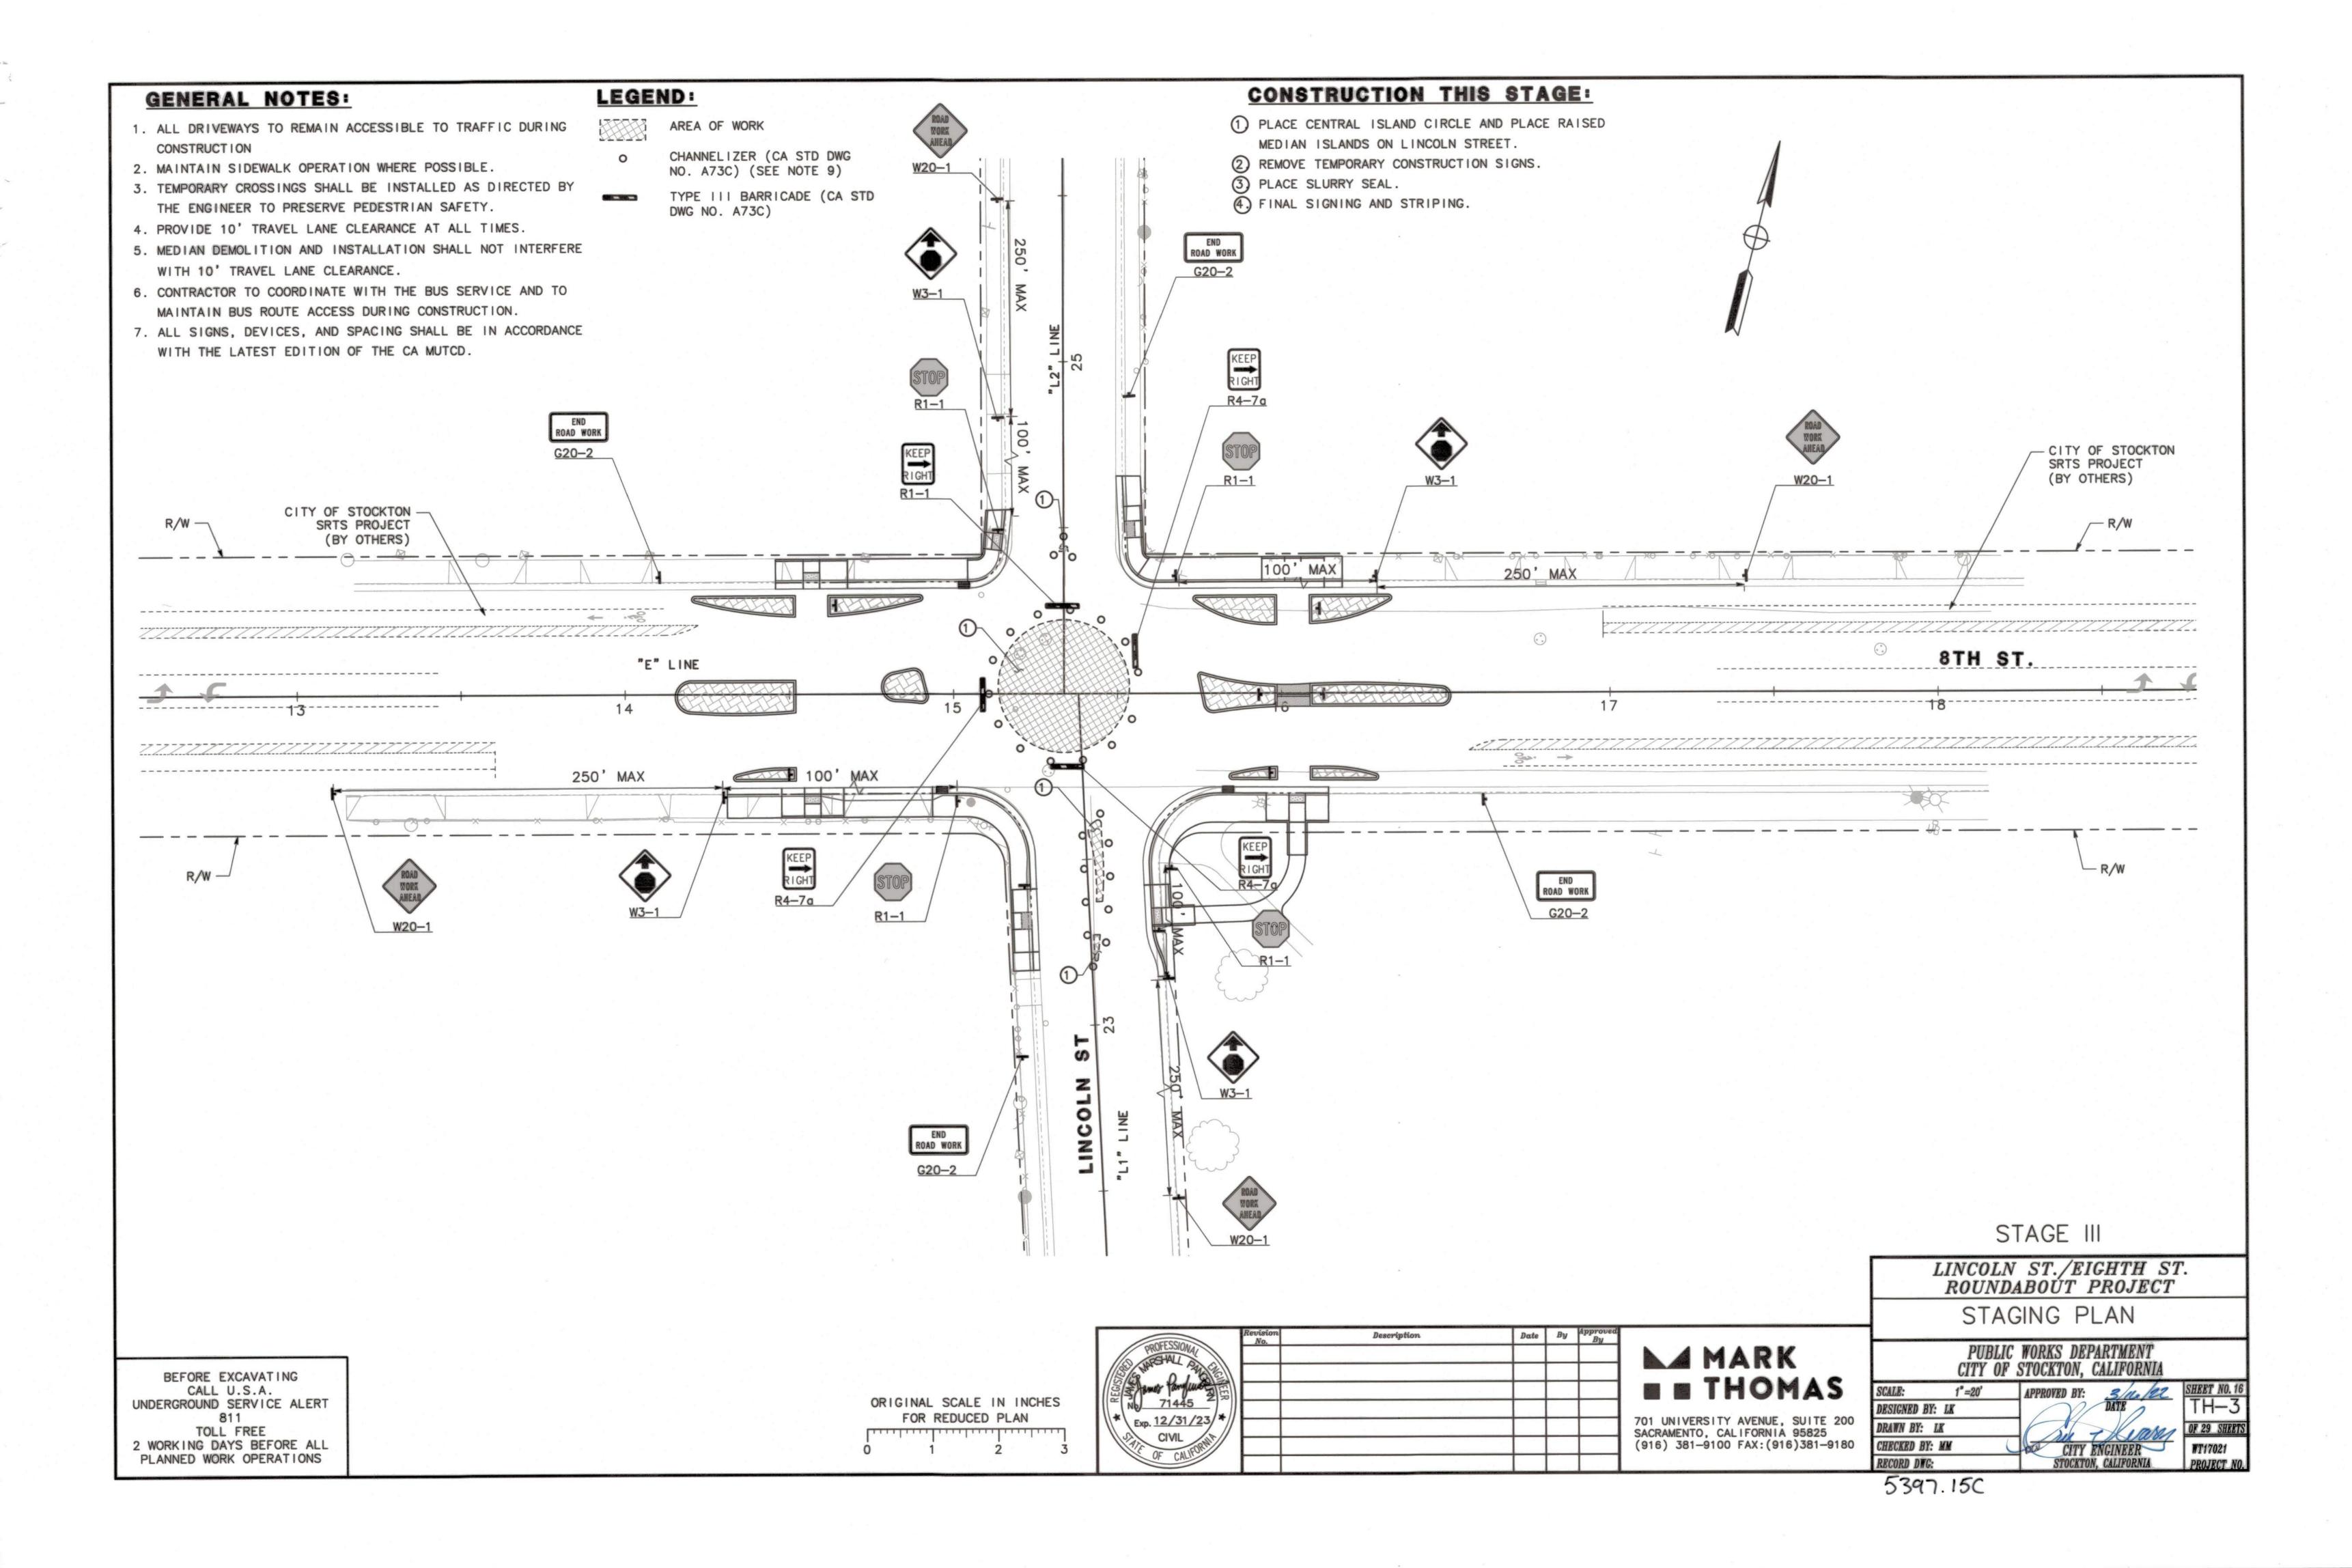

ELECTRICAL GENERAL NOTES

- ALL ELECTRICAL WORK SHALL BE PERFORMED IN ACCORDANCE WITH THE LATEST EDITION OF CITY OF STOCKTON STANDARD SPECIFICATIONS AND PLANS, THE CURRENT STATE OF CALIFORNIA, DEPARTMENT OF TRANSPORTATION STANDARD SPECIFICATIONS AND PLANS AND SUBSEQUENT REVISED STANDARD PLANS, AND THE SPECIAL PROVISIONS. IN CASE OF DIFFERENCES BETWEEN CITY AND CALTRANS STANDARDS, CITY STANDARDS SHALL GOVERN.
- 2. LOCATIONS OF EXISTING UTILITIES, AS SHOWN ON THE PLANS, ARE APPROXIMATE ONLY. THE CONTRACTOR SHALL CONTACT ALL UTILITIES TO VERIFY UNDERGROUND AND OVERHEAD UTILITIES. THE CONTRACTOR SHALL CALL 1-800-642-2444, UNDERGROUND SERVICE ALERT (U.S.A), 48 HOURS PRIOR TO ALL EXCAVATION.
- 3. THE CONTRACTOR SHALL VERIFY OVERHEAD AND UNDERGROUND CLEARANCE REQUIREMENTS WITH AT&T, PG&E, AND OTHER AFFECTED UTILITY PRIOR TO THE START OF WORK.
- 4. THE LOCATION OF ALL PULL BOXES, CONDUITS AND OTHER EQUIPMENT SHOWN ON THIS PLAN ARE APPROXIMATE AND MAY BE CHANGED TO SUIT FIELD CONDITIONS AS DIRECTED BY THE ENGINEER.
- 5. ALL PULL BOXES SHALL BE LOCATED IN THE SIDEWALK. WHERE APPLICABLE, PLACE PULL BOXES BEHIND SIDEWALK RAMPS, AND AWAY FROM DRIVEWAYS.
- 6. ALL STREET LIGHTING PULL BOXES SHALL HAVE SECURITY LIDS PER SPECIAL PROVISIONS.
- 7. ALL NEW PULL BOXES SHALL BE No. 5 UNLESS OTHERWISE NOTED ON THE PLAN. STREET LIGHTING PULL BOX COVERS SHALL BE INSCRIBED "STREET LIGHTING".
- 8. THE CONTRACTOR SHALL MAINTAIN PEDESTRIAN ACCESS AS REQUIRED UNLESS OTHERWISE NOTED.
- ALL CONDUCTORS SHALL BE COPPER.
- 10. LIGHTING LUMINAIRES SHALL HAVE HOUSE-SIDE SHIELD.
- 11. RRFB ASSEMBLY, APS AND RRFB LIGHT BAR CABLES MUST BE FURNISHED BY SAME MANUFACTURER.
- 12. THIS PLAN IS ACCURATE FOR ELECTRICAL WORK ONLY.

LEGENDS AND ABBREVIATIONS:

CITY STANDARD STREET LIGHT WITH 12' MAST ARM AND 107 W LED Lum.

NEW DOUBLE-SIDED RRFB ASSEMBLY WITH POLE.

NEW SINGLE-SIDED RRFB ASSEMBLY WITH POLE.

PG&E

PACIFIC GAS & ELECTRIC COMPANY

RRFB

RECTANGULAR RAPID FLASHING BEACON

PROJECT NOTES:

- 1 INSTALL METERED/UNMETERED TYPE III-AF SERVICE EQUIPMENT ENCLOSURE. SEE SHEET E-6 FOR DETAILS. FRONT DOOR SHALL FACE NORTH.
- 2 3"C, 3#2 (SERVICE).
- 3 3"C, PT. INSTALL CONDUIT PER PG&E REQUIREMENT.
- 4 INSTALL TYPE 15TS STANDARD WITH RRFB ASSEMBLY. SEE DETAIL B ON SHEET E-2.
- 5 INSTALL CITY STANDARD IP PTZ CCTV SYSTEM ON LUMINAIRE ARM PER MANUFACTURER'S RECOMMENDATION. SEE MOUNTING DETAILS ON E-4.
- 6 INSTALL WIRELESS RADIO ASSEMBLY ON STREET LIGHTING POLE OR MAST ARM PER MANUFACTURER'S RECOMMENDATION.
- 7 INSTALL MANAGED ETHERNET SWITCH AND POWER OVER ETHERNET INJECTOR IN CONTROLLER CABINET.
- 8 EXISTING TYPE M 60 CONTROLLER ASSEMBLY.

BEFORE EXCAVATING CALL U.S.A. UNDERGROUND SERVICE ALERT TOLL FREE 2 WORKING DAYS BEFORE ALL PLANNED WORK OPERATIONS

- 9 REMOVE EXISTING Lum. INSTALL NEW 107 W LED Lum TO EXISTING STANDARD.
- 10 INSTALL TYPE 1-B STANDARD (13') WITH RRFB ASSEMBLY. SEE DETAIL A ON SHEET E-2.
- 11 INSTALL PG&E No. 2 PULL BOX.
- 12 COORDINATE WITH PG&E FOR SERVICE CONNECTION.
- 13 ADD ONE CAT 5E CABLE IN EXISTING CONDUIT.
- 14 INSTALL CITY STANDARD TYPE M CONTROLLER CABINET WITH CCTV AND RRFB CONTROL UNITS WITH TWO 19U RACKS AND NETWORK EQUIPMENT. FRONT DOOR SHALL FACE NORTH. SEE DETAILS ON SHEET E-4 AND E-5.
- 15 INSTALL TYPE 15TS STANDARD WITH RRFB ASSEMBLY. SEE DETAIL D ON SHEET E-3.
- 16 INSTALL TYPE 1-B STANDARD (13') WITH RRFB ASSEMBLY. SEE DETAIL C ON SHEET E-3.
- 17 INSTALL DUAL PEUS TO THE TOP OF POLE.
- 18 NO APS TO BE INSTALLED ON THIS POLE.

ORIGINAL SCALE IN INCHES FOR REDUCED PLAN

KIN Y. CHAN

₩ No. <u>55391</u>

#Exp. 12/31/22


W 8th St

EXISTING PG&E SERVICE POINT (120/240 V)
LOAD: 5-107 W LED LUMINAIRE (UNMETERED)

60 W CCTV (METERED)

± 300 W RRFB (METERED)

14+00

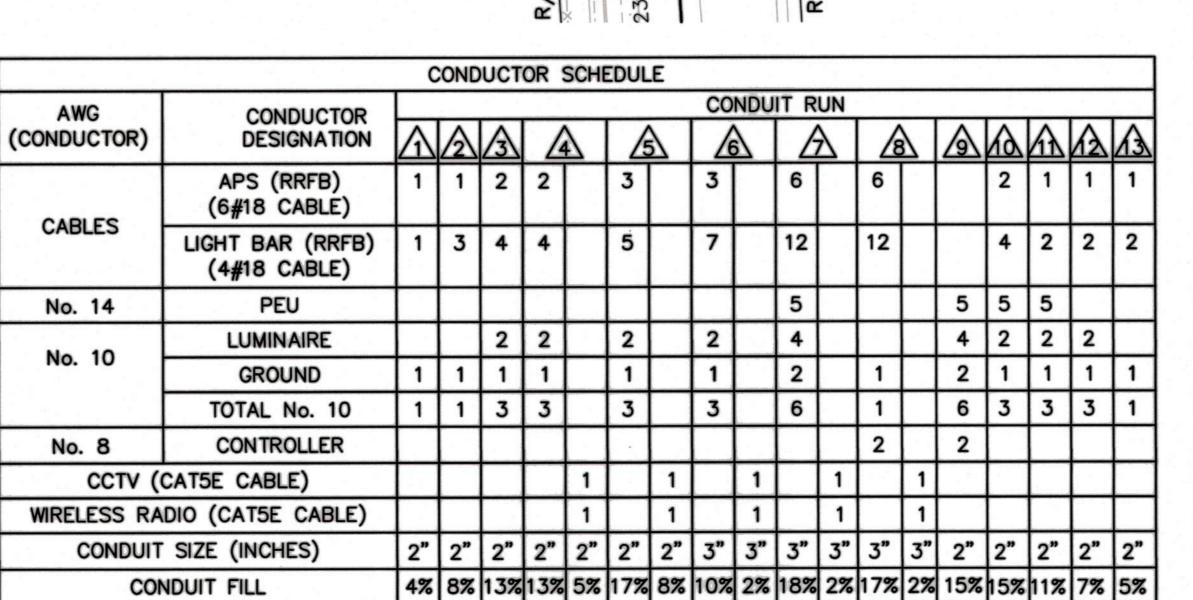

Description

			EQUIP	MENT	SC	HEDULE			
POLE	STANI	DARD	LUMIN	NAIRE		APS	LOCAT	ION *	
No.	TYPE	HGT	MAST ARM	LEC	,	ARROW	A	В	
(1-B	13'				RIGHT	"E" 14+47 OFFSET 30	5.26' Rt	
ⅎ	1-B	13'					"E" 14+50 OFFSET 0)	
0	PBA POST	4'-7"				LEFT	"E" 14+56 OFFSET 40.67' L		
0	15TS	30'	12'	107	w		"E" 14+70 OFFSET 40.05' Lt		
(3)	15TS	30'	12'	107	w		"E" 15+66 OFFSET 4	3	
<u> </u>	1-B	13'				RIGHT	"E" 16+14 OFFSET 4		
<u></u>	1-B	13'					"E" 15+97	7	
€	1-B	13'				RIGHT	"E" 16+01 OFFSET 3		
Θ	15TS	30'	12'	107	w	RIGHT	"L1" 23+2	3.73' Rt	
0	1-B	13'				RIGHT	"L1" 23+4 OFFSET 2	Charles and the control of the contr	
\otimes	15	30'	12'	107	w		5'-9"	7'-7"	

SEE E-4 FOR POLE LOCATION DETAILS

16 APS

R/W

R/W

7 14

4 17 APS

Date By Approved

Y&C

- (916) 366-8000

3250 RAMOS CIRCLE SACRAMENTO, CA 95827

TRANSPORTATION CONSULTANTS, INC.

W 8th St

78

LINCOLN ST./EIGHTH ST. ROUNDABOÚT PROJECT


LIGHTING, CCTV & RRFB SYSTEMS


PUBLIC WORKS DEPARTMENT CITY OF STOCKTON, CALIFORNIA


SCALE: 1"=20' DESIGNED BY: TC DRAWN BY: TC CHECKED BY: KYC RECORD DWG:


HEET NO. 1 E-1 OF 29 SHEETS CITY ENGINEER STOCKTON, CALIFORNIA

5397.16C

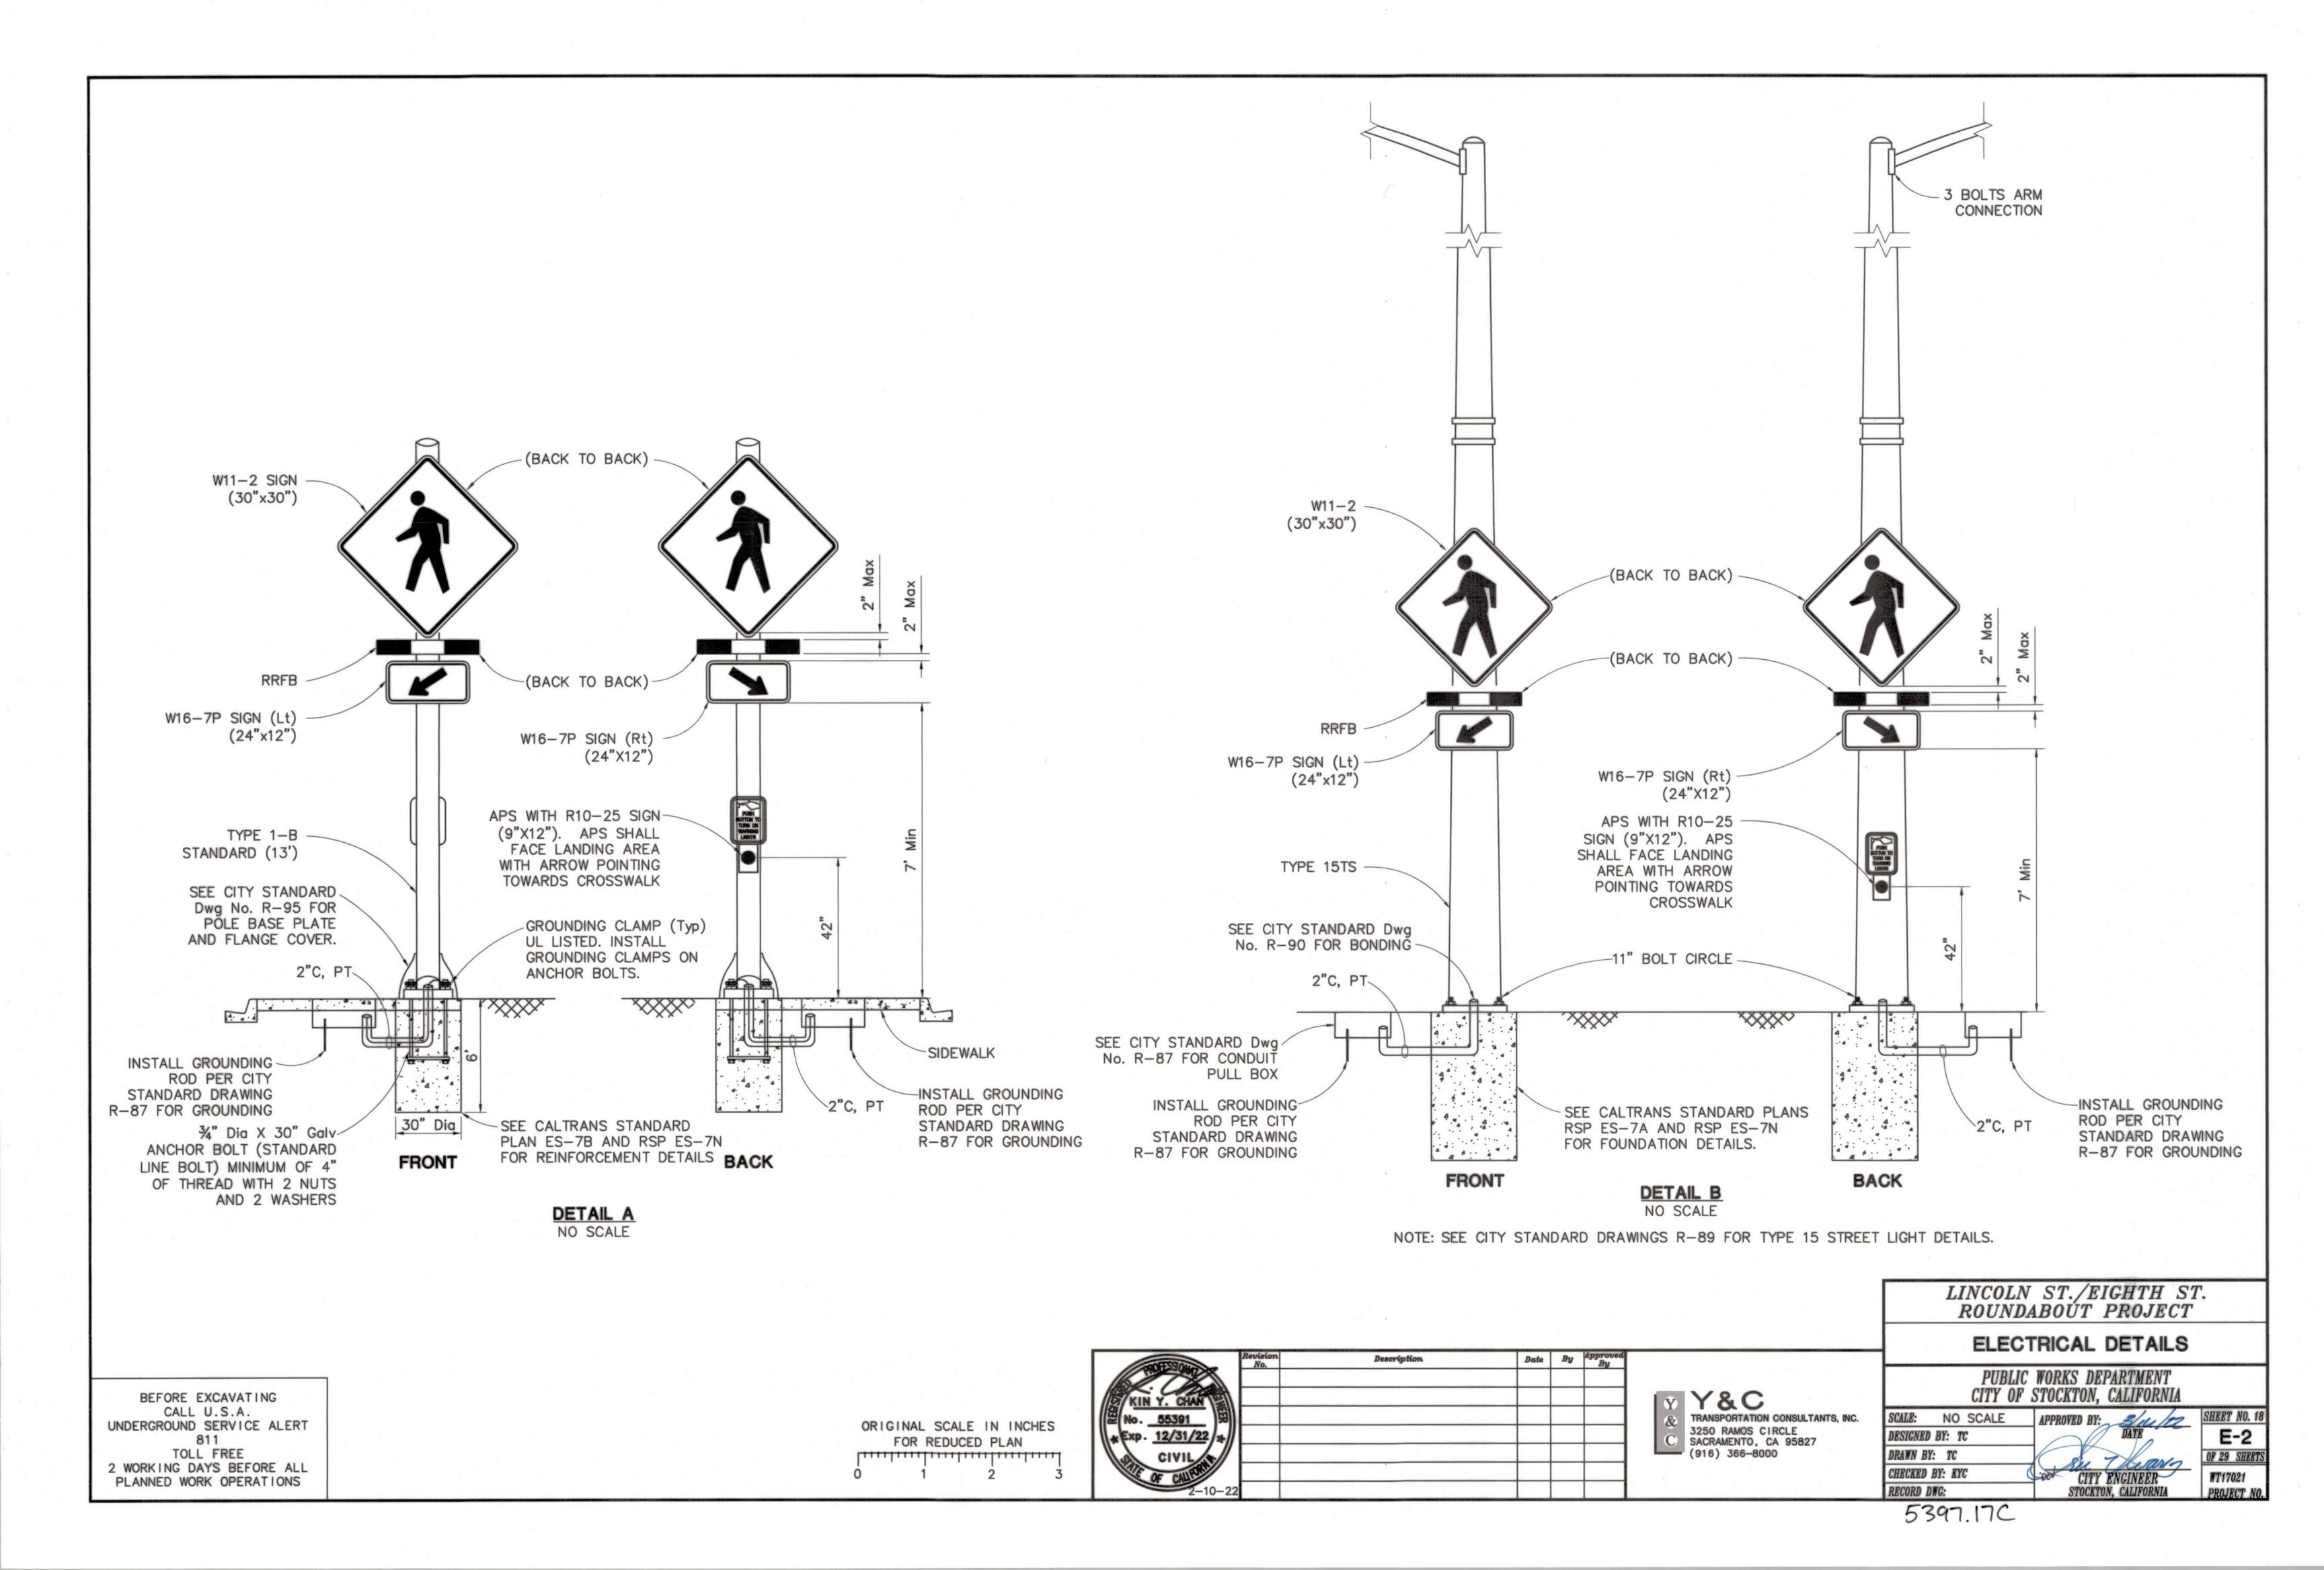

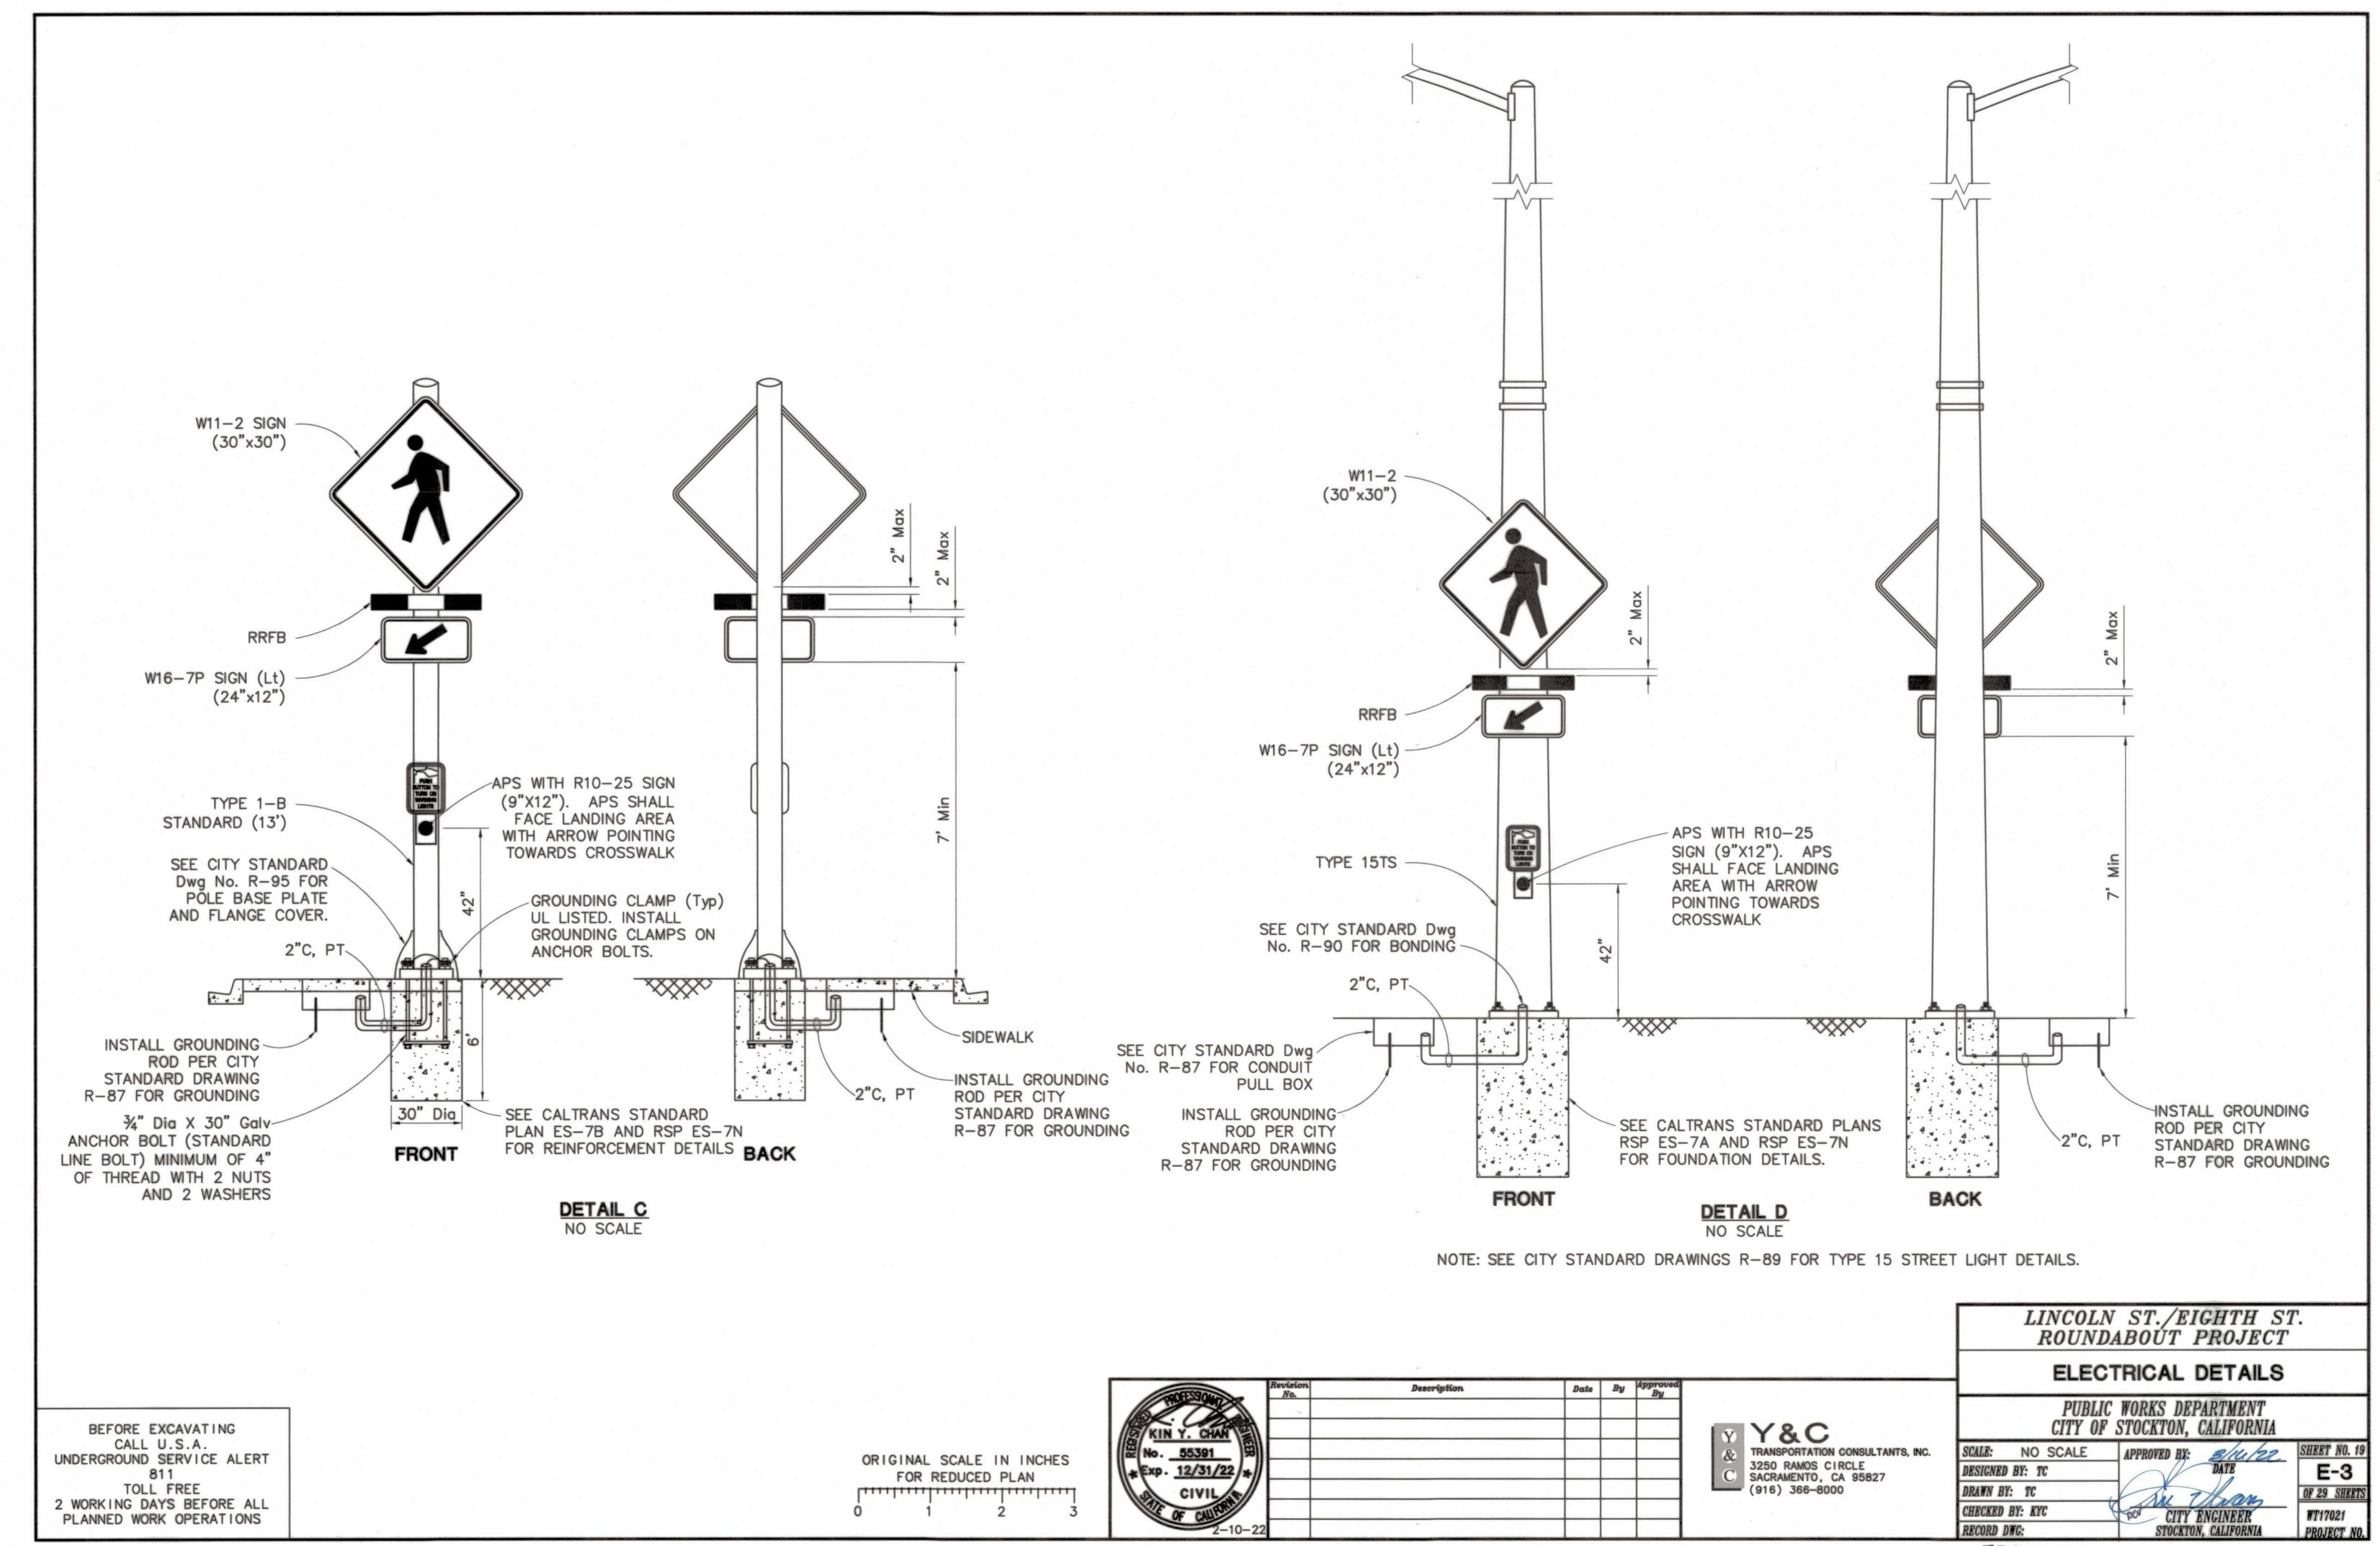


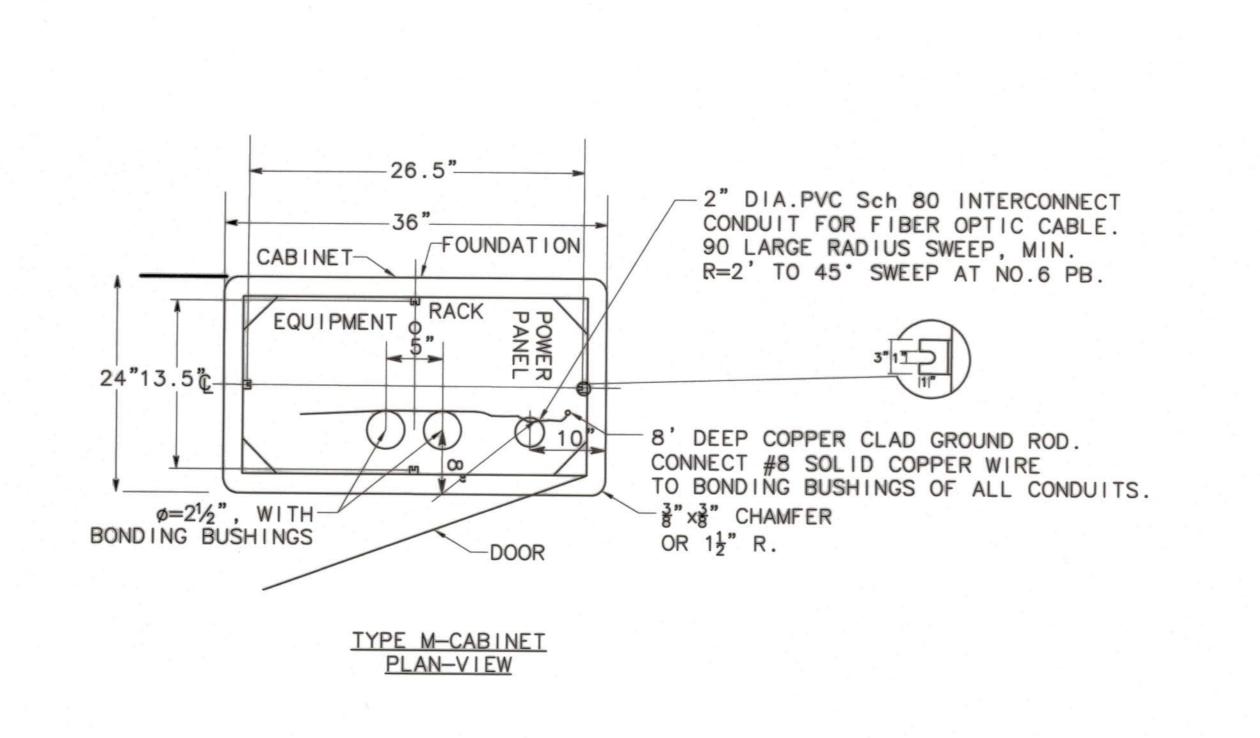

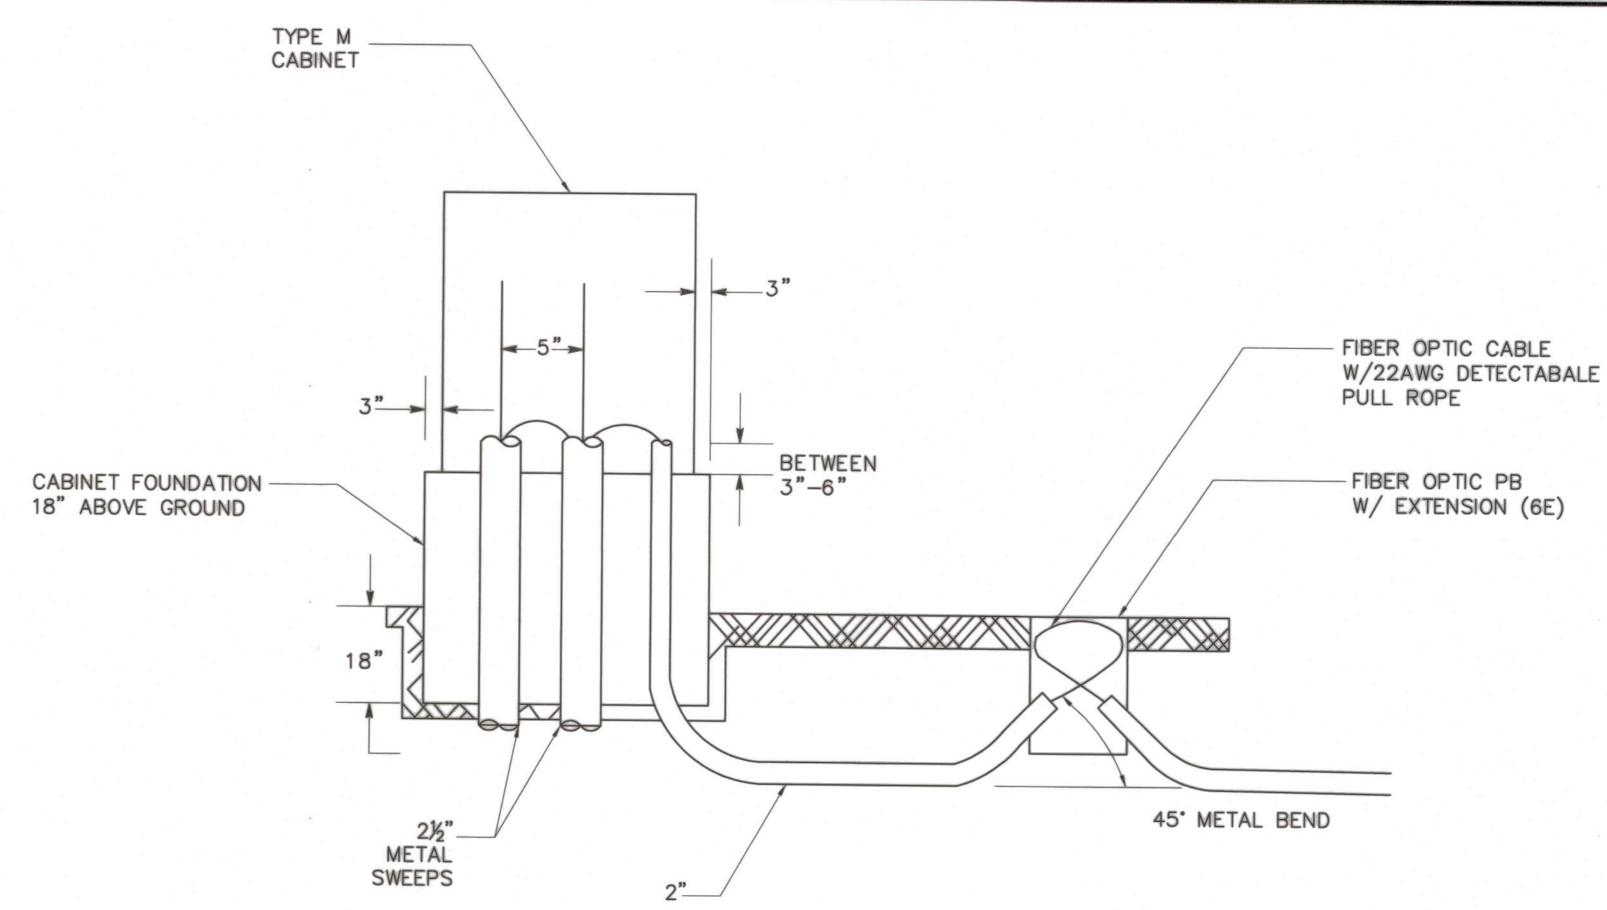


TYPE M CONTROLLER CABINET FOUNDATION

NO SCALE

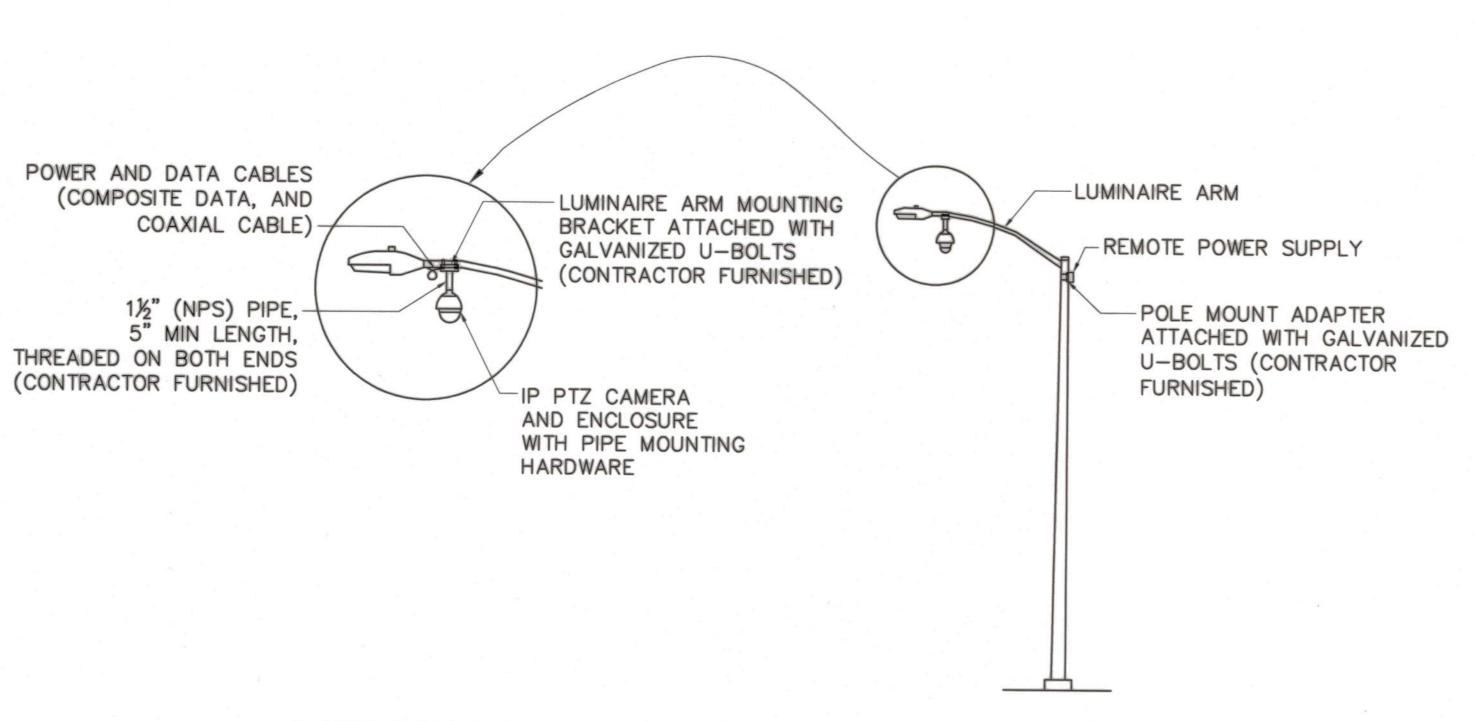

TYPE M-CABINET FRONT-VIEW

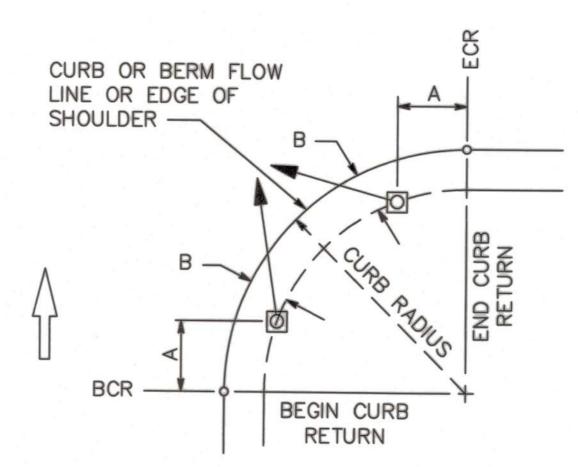

POLE LOCATION DETAIL NO SCALE

NOTE: FOR A AND B DIMENSIONS, SEE POLE AND EQUIPMENT SCHEDULE. REFER TO CALTRANS STANDARD PLAN ES-4C FOR DETAILS.

CCTV CAMERA LUMINAIRE ARM MOUNT NO SCALE

BEFORE EXCAVATING CALL U.S.A. UNDERGROUND SERVICE ALERT 811

TOLL FREE 2 WORKING DAYS BEFORE ALL PLANNED WORK OPERATIONS ORIGINAL SCALE IN INCHES FOR REDUCED PLAN

MOFESSOR	Revision No.	Description	Date	By	Approved By
KIN Y. CHAN				-	
No. 55391					\vdash
* CIVII					\vdash
CIVIL		-			
2-10-	22				

Y X&C
TRANSPORTATION CONSULTANTS, INC. 3250 RAMOS CIRCLE SACRAMENTO, CA 95827 (916) 366-8000

LINCOLN ST./EIGHTH ST. ROUNDABOUT PROJECT

ELECTRICAL DETAILS

PUBLIC WORKS DEPARTMENT CITY OF STOCKTON, CALIFORNIA

SCALE: NO SCALE DESIGNED BY: TC DRAWN BY: TC CHECKED BY: KYC RECORD DWG:


CITY ENGINEER STOCKTON, CALIFORNIA

E-4


OF 29 SHEET

WT17021

5397.19C

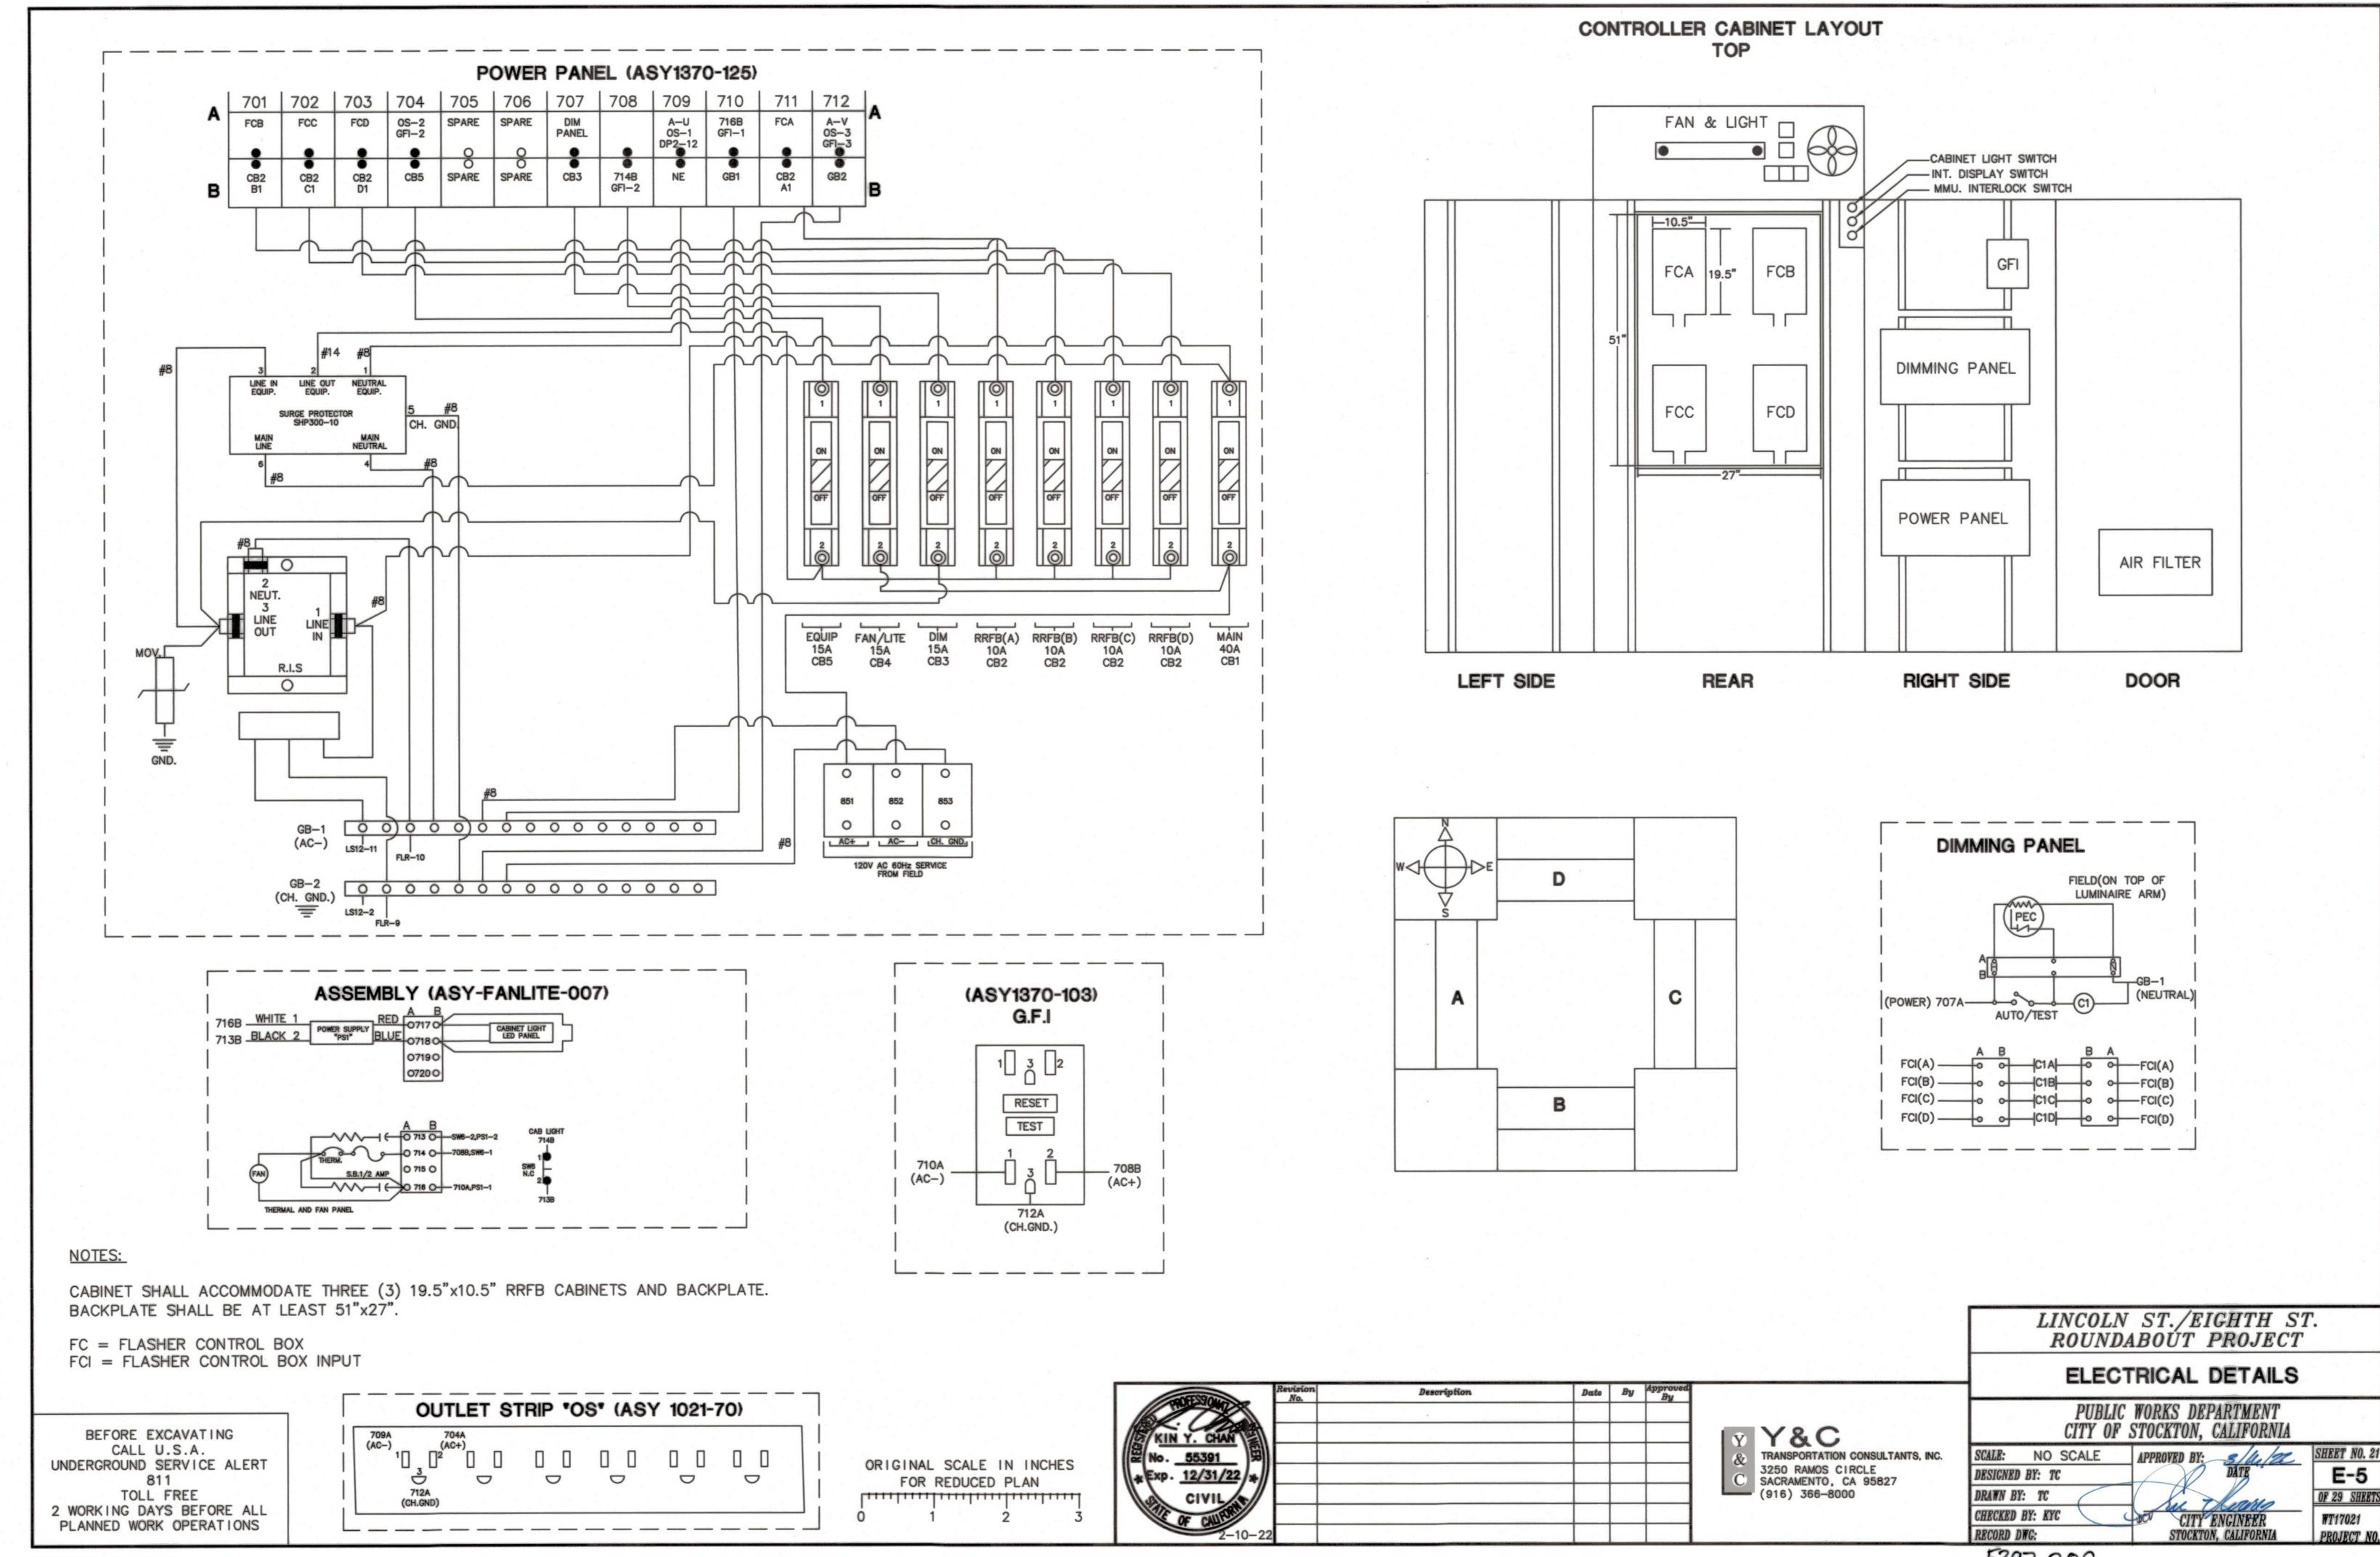

5397.20C

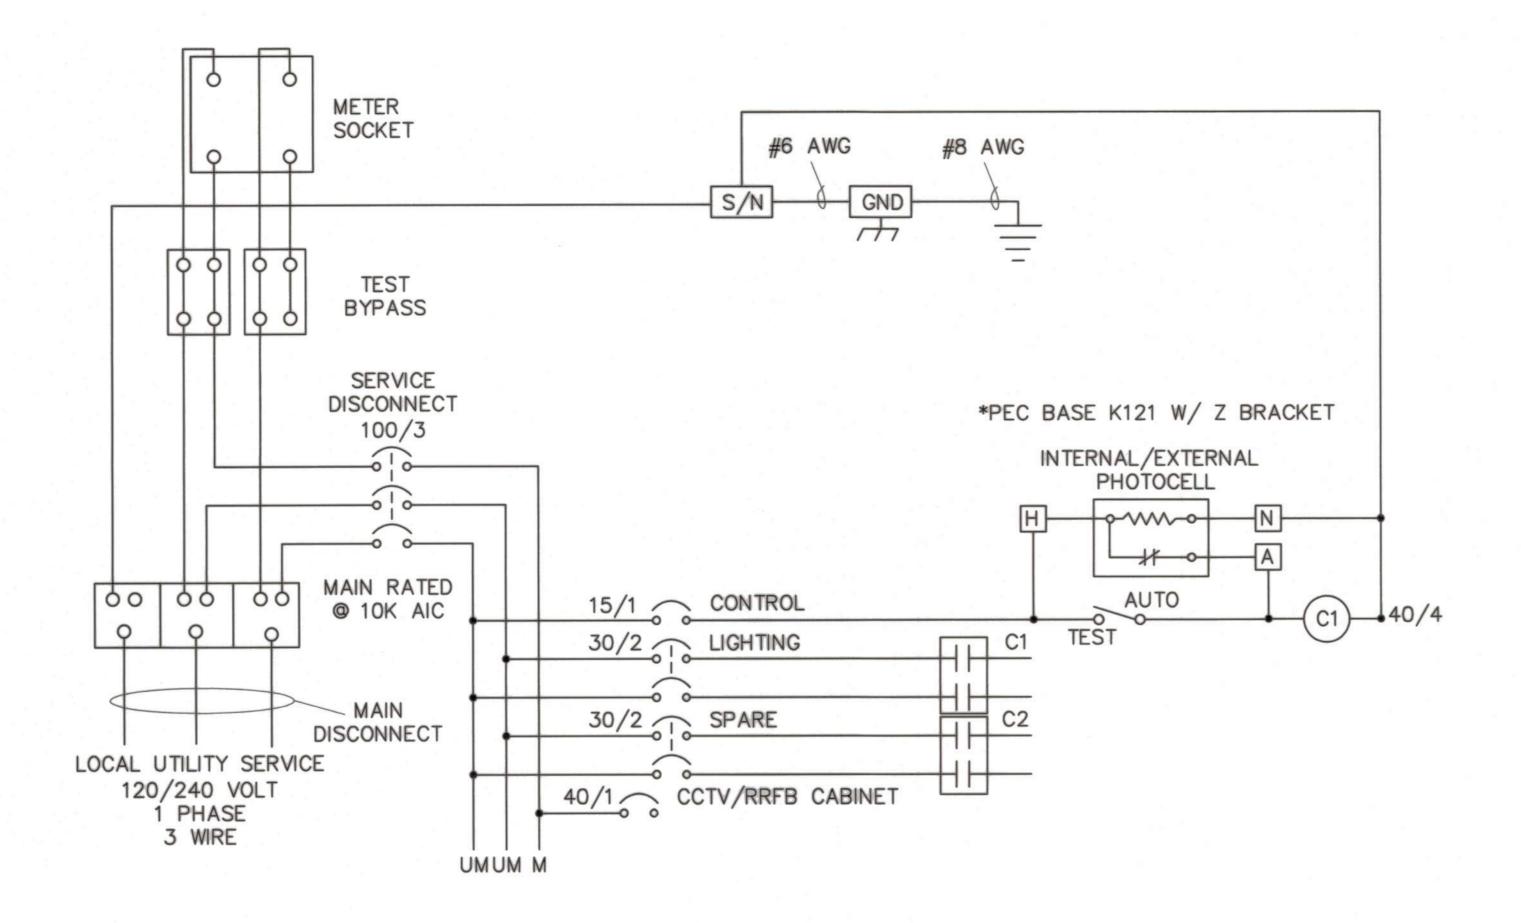


TYPE III-AF SERVICE EQUIPMENT WIRING DIAGRAM

ENCLOSURE CONSTRUCTION NOTES:

- EXTERIOR, 1/8" ALUMINUM, AND INTERIOR 14 GA COLD ROLLED STEEL ELECTRICALLY WELDED AND REINFORCED WHERE REQUIRED.
- CONSTRUCTION WILL BE NEMA 3R, RAINTIGHT.
- 3. ALL NUTS, BOLTS AND SCREWS WILL BE STAINLESS STEEL.
- 4. NUTS, BOLTS & SCREWS WILL NOT BE VISIBLE FROM OUTSIDE OF ENCLOSURE.
- 5. NAMEPLATES WILL BE PROVIDED AS REQUIRED.
- 6. CONTROL WIRING WILL BE MARKED AT BOTH ENDS BY PERMANENT WIRE MARKERS.
- 7. A PLASTIC COVERED WIRING DIAGRAM WILL BE ATTACHED TO THE INSIDE OF THE FRONT DOOR.
- 8. ENCLOSURE WILL BE FACTORY WIRED AND CONFORM TO REQUIRED NEMA AND UL 508A STANDARDS.
- 9. ANODIZE AFTER FABRICATION.

BEFORE EXCAVATING
CALL U.S.A.
UNDERGROUND SERVICE ALERT
811
TOLL FREE
2 WORKING DAYS BEFORE ALL
PLANNED WORK OPERATIONS

ORIGINAL SCALE IN INCHES
FOR REDUCED PLAN

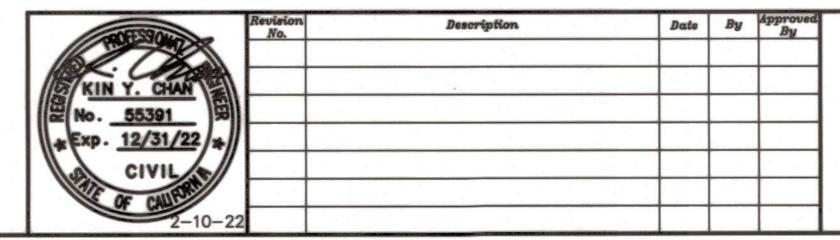

Y & C
TRANSPORTATION CONSULTANTS, INC.
3250 RAMOS CIRCLE
SACRAMENTO, CA 95827
(916) 366-8000

LINCOLN ST./EIGHTH ST. ROUNDABOUT PROJECT

ELECTRICAL DETAILS

PUBLIC WORKS DEPARTMENT CITY OF STOCKTON, CALIFORNIA

E-6

OF 29 SHEET

WT17021

SCALE: NO SCALE APPROVED BY:

DESIGNED BY: TC

DRAWN BY: TC

DESIGNED BY: TC

DRAWN BY: TC

CHECKED BY: KYC

RECORD DWG:


DATE

DATE

DATE

CHECKED BY: KYC

STOCKTON, CALIFORNIA

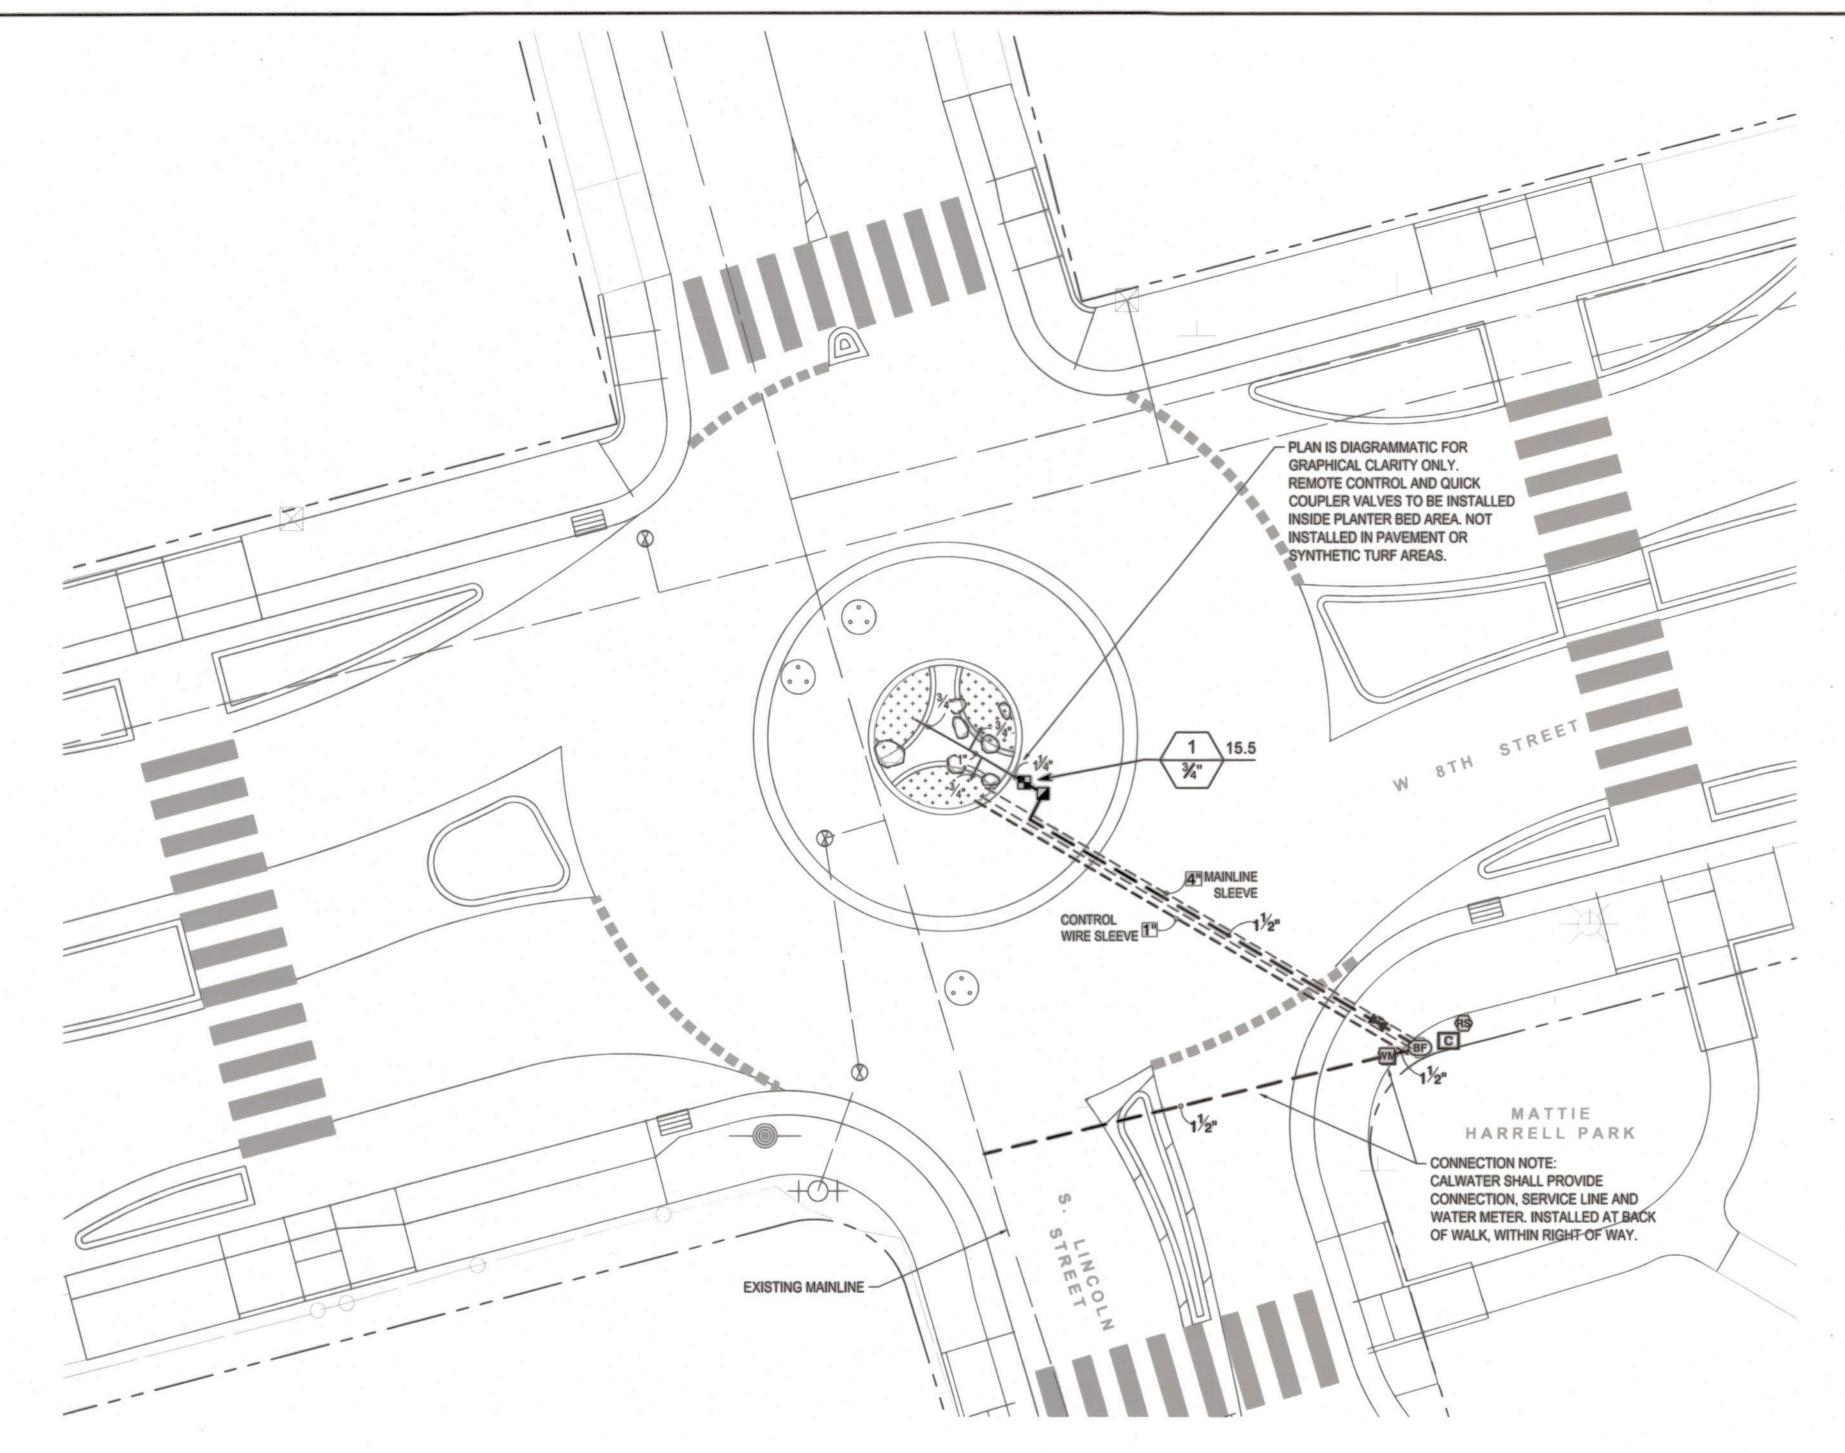

GENERAL IRRIGATION NOTES

- 1. ALL WORK SHALL BE COMPLETED IN ACCORDANCE WITH ALL STATE AND LOCAL CODES AND STANDARDS.
- 2. THE INTENT OF THIS IRRIGATION SYSTEM IS TO PROVIDE THE MINIMUM AMOUNT OF WATER REQUIRED TO SUSTAIN GOOD PLANT HEALTH. LANDSCAPE SUBCONTRACTOR SHALL GUARANTEE 100% COVERAGE OF SYSTEM.
- INSTALL NEW REMOTE CONTROL VALVE BOXES 12" FROM WALK, CURB, EQUIPMENT, OR LANDSCAPE FEATURE. AT MULTIPLE VALVE BOX GROUPS, EACH BOX SHALL BE AN EQUAL DISTANCE FROM THE WALK, CURB, LAWN, ETC. AND EACH BOX SHALL BE 12" APART. SHORT SIDE OF RECTANGULAR VALVE BOXES SHALL BE PARALLEL TO WALK, CURB, LAWN, ETC.
- ALL PVC SLEEVES UNDER PAVEMENT AND ROADWAYS TO BE SCH. 40. SLEEVES TO BE TWICE THE DIAMETER OF PIPE OR WIRE BUNDLE THAT WILL PASS THROUGH SLEEVE. CHANGE ALL RING-TITE PIPE THAT WOULD PASS THROUGH SLEEVES TO CLASS 315 SOLVENT WELD PIPE OF SAME SIZE.
- 5. THE IRRIGATION CONTRACTOR SHALL NOT WILLFULLY INSTALL THE SYSTEM AS DESIGNED WHEN IT IS OBVIOUS IN THE FIELD THAT OBSTRUCTIONS OR GRADE DIFFERENCES EXIST THAT WERE NOT IDENTIFIED IN THE DRAWINGS. SUCH CONDITIONS SHALL BE BROUGHT TO THE ATTENTION OF THE LANDSCAPE ARCHITECT OTHERWISE, THE CONTRACTOR MUST ASSUME FULL RESPONSIBILITY FOR ANY NECESSARY REVISIONS.

A CERTIFICATE OF COMPLETION SHALL BE PROVIDED TO THE CITY OF STOCKTON COMMUNITY DEVELOPMENT DEPARTMENT, BY THE PROJECT LANDSCAPE ARCHITECT. THE CERTIFICATION SHALL INCLUDE ALL REQUIREMENTS AS NOTED IN SECTION 492.9 OF THE MODEL WATER EFFICIENT LANDSCAPE ORDINANCE.

EFFICIENT LANDSCAPE ORDINANCE AND APPLY THEM FOR THE EFFICIENT USE OF WATER IN THE LANDSCAPE AND IRRIGATION DESIGN PLANS.

I COMPLY WITH THE CRITERIA OF THE MODEL WATER

ROBERT J. NORBUTAS, JR., RLA 5595

IRRIGATION SCHEDULE NOTE

PROJECT INCLUDES A NEW IRRIGATION SYSTEM AND REQUIRES THE FOLLOWING MEASURES TO BE MET:

No.5595

Exp. 11/30/22/

DATE SIGNED: 02/02/22

IRRIGATION MUST BE SCHEDULED BETWEEN 9:00 P.M. AND 6:00 A.M. UNLESS WEATHER CONDITIONS PREVENT IT.

Description

. OPERATION OF THE IRRIGATION SYSTEM OUTSIDE THE NORMAL WATERING WINDOW IS ALLOWED FOR-AUDITING AND SYSTEM MAINTENANCE.

LANDSCAPE SUMMARY

TOTAL IRRIGATED LANDSCAPE AREA

Date By Approv

IRRIGATION LEGEND

|+ + + + +|

SYMBOL

MANUFACTURER/MODEL/DESCRIPTION

DIG Corporation P52-075 or approved equal

Hunter RZWS-SLEEVE-10-CV or approved equal

swing joint for connection to 1/2" pipe, Check Valve.

50 emitters (1 assigned to each 1 gal plant) 50 emitters (2 assigned to each 5 gal plant)

MANUFACTURER/MODEL/DESCRIPTION

Rain Bird 44-LRC or approved equal

Nibco T-113 or approved equal

Zurn 975XL 1" or approved equal

Reduced Pressure Backflow device.

Install per manufacture's specifications.

Hunter MINI-CLIK or approved equal

Water Meter 1"

Irrigation Mainline: PVC Schedule 40

Valve Callout

____ Pipe Sleeve: PVC Schedule 40

SBBC-45CR, locking, Insulating Blanket cover.

DIG Corporation LEIT XRC04 or approved equal

controller. Install per manufacture's specifications.

Line and water meter provided by CalWater.

Irrigation Lateral Line: PVC Schedule 40

Area to Receive Drip Emitters

Emitter Notes:

Drip Control Valve Kit 3/4", PGV globe valve with 3/4" HY075 filter system. Pressure Regulation: 25 psi. 150 mesh stainless steel screen. Solenoid adapter (DIG 30-922). Configure per manufacturer's specifications.

10" long RZWS with Sleeve installed. .50 GPM bubbler per plant, and 1/2"

1" Brass Quick-Coupling Valve, with Corrosion-Resistant Stainless Steel Spring, Locking Thermoplastic Rubber Cover, and 2-Piece Body.

Class 125 bronze gate shut off valve with wheel handle, same size as

mainline pipe diameter at valve location. Size Range - 1/4" - 3"

StrongBox Low Profile Smooth Touch enclosure, or equal.

MARK **THOMAS**

701 UNIVERSITY AVENUE, SUITE 200 SACRAMENTO, CALIFORNIA 95825 (916) 381-9100 FAX: (916) 381-9180


4 Station solar powered controller with programming key (LEIT KEY), rain sensor connection (DIG SKIT8821-4), and radio communication to handset device (LEIT MULTI-PRO). Use mounting kit (DIG MKIT X) with 35" mounting column (DIG MCOLXS) to install at location shown on plans. Rain Sensor. Mount on 1" galvanized pipe, 6' high. Connect to weatherproof sensor adaptor (DIG SKIT8821-4) to communicate with Project Point of Connection after new 1" water meter. Connection, Service Typical pipe sleeve for irrigation pipe. Min. size 2x diameter of pipe being sleeved. Extend sleeves 24" beyond edges of paving or construction.

QUANTITIES MAY VARY FROM LEGEND.

CONTRACTOR TO VERIFY.

IRRIGATION EQUIPMENT AND PIPING IS DIAGRAMMATIC FOR GRAPHICAL CLARITY.

- 1. ALL PIPING, VALVES, ETC. SHOWN WITHIN PAVED AREAS IS FOR DESIGN CLARIFICATION ONLY AND SHALL BE INSTALLED IN PLANTING AREAS WHERE POSSIBLE.
- 2. AVOID ANY CONFLICTS BETWEEN THE IRRIGATION SYSTEM AND PLANTING AND ARCHITECTURAL FEATURES.

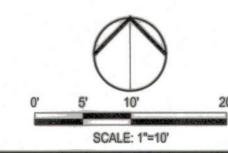

LINCOLN ST./EIGHTH ST. ROUNDABOUT PROJECT


IRRIGATION PLAN


PUBLIC WORKS DEPARTMENT CITY OF STOCKTON, CALIFORNIA

SCALE: 1"-'10' DESIGNED BY: RJN DRAWN BY: RJN CHECKED BY: RJN RECORD DWG: STOCKTON, CALIFORNIA

BEFORE EXCAVATING CALL U.S.A. UNDERGROUND SERVICE ALERT TOLL FREE 2 WORKING DAYS BEFORE ALL PLANNED WORK OPERATIONS



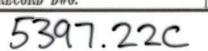

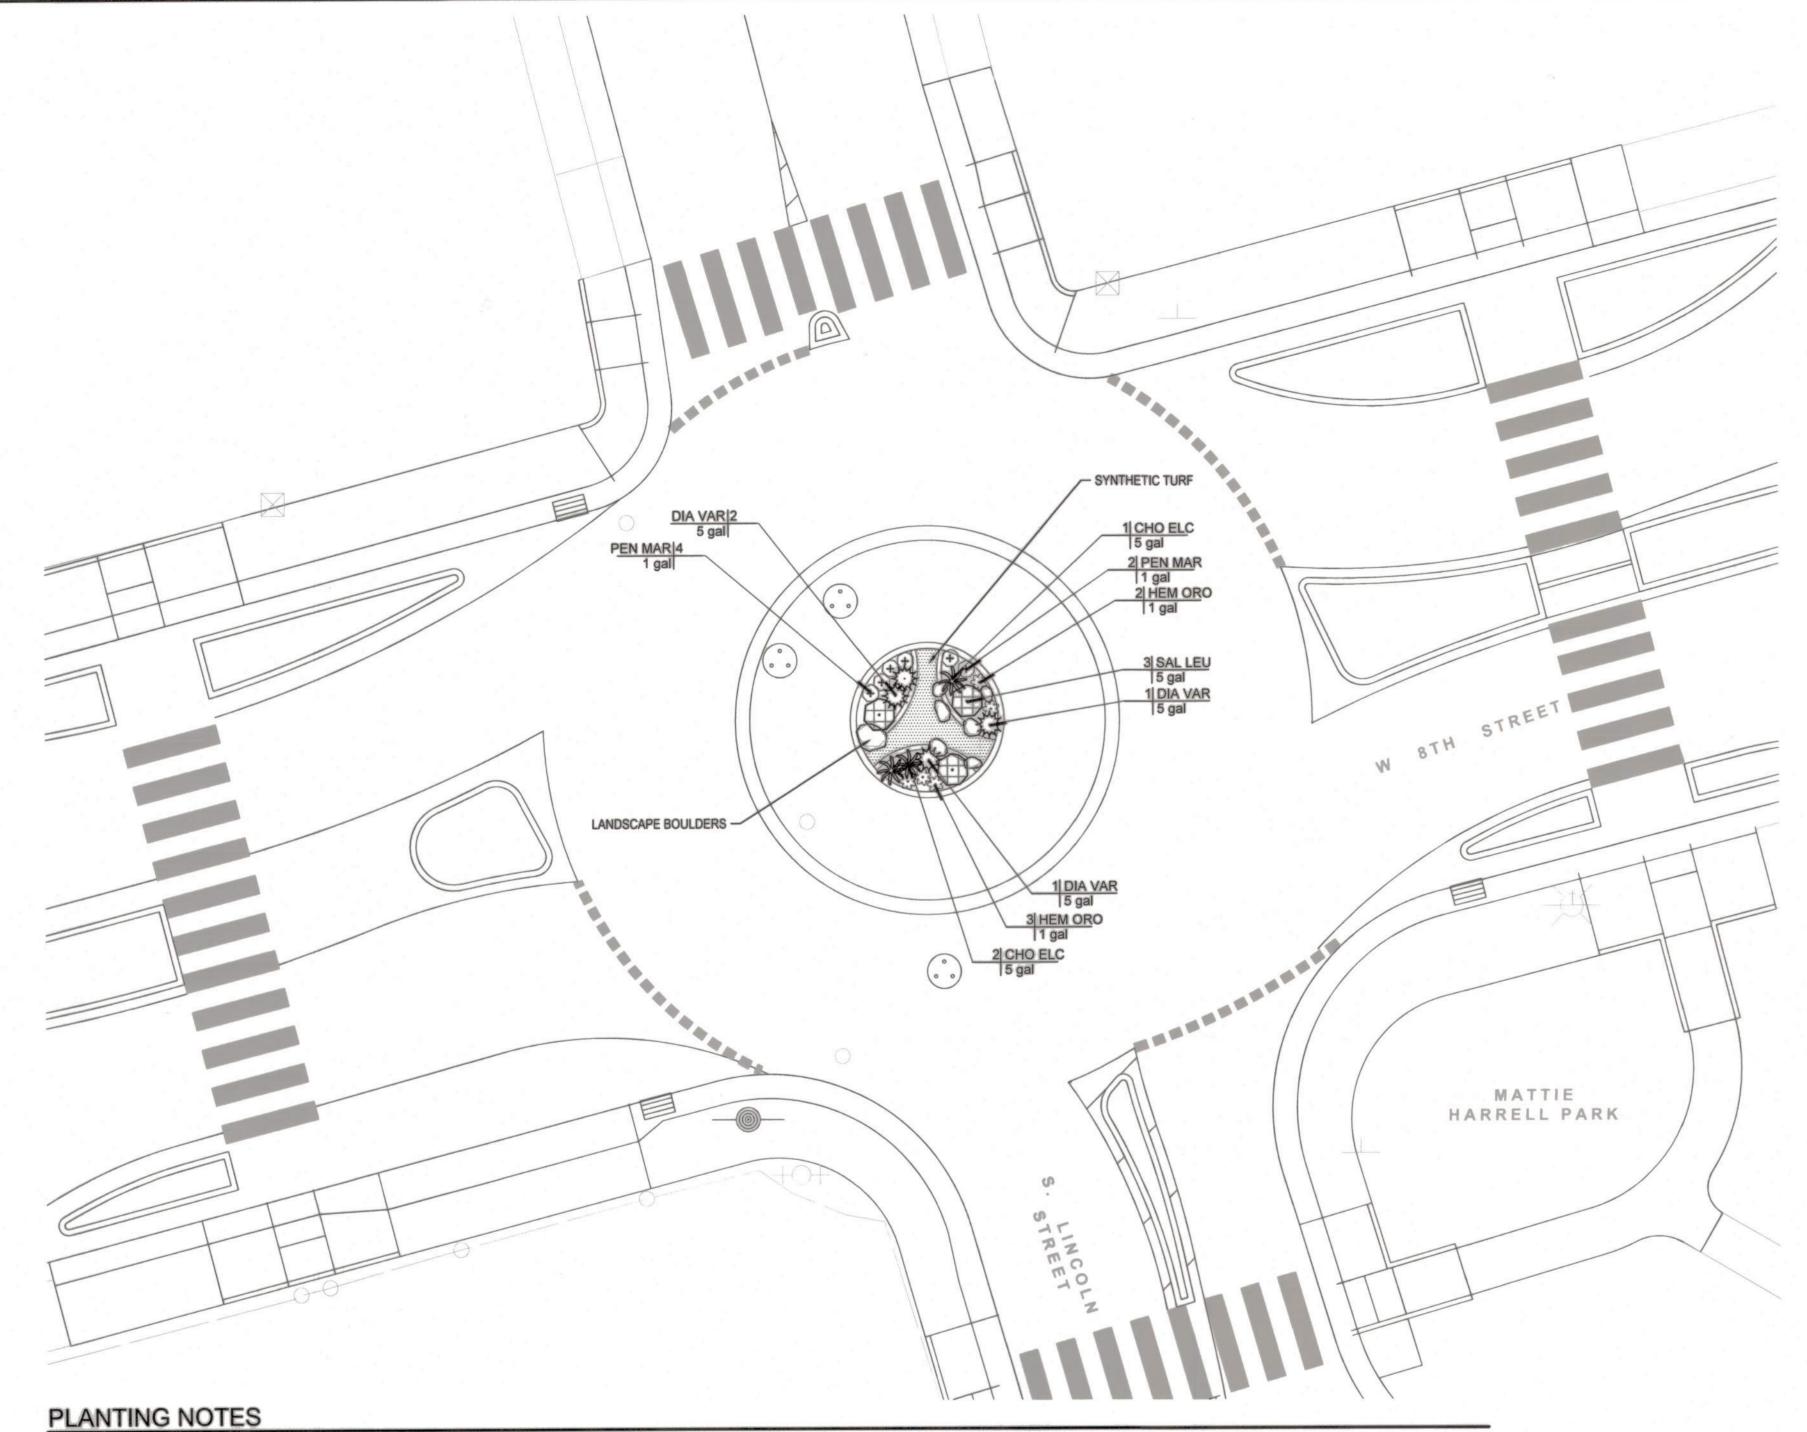

- 1. IF A DISCREPANCY BETWEEN THESE PLANS AND ACTUAL ON-SITE CONDITIONS OCCURS, THE CONTRACTOR IS TO NOTIFY THE OWNER IMMEDIATELY, BEFORE PROCEEDING WITH WORK, FOR A
- ALL WORK SHALL BE COMPLETED IN ACCORDANCE WITH LOCAL AND STATE STANDARDS AND CODES.
- 3. ALL PLANTS BROUGHT ONTO THE SITE SHALL BE WATERED AND PROTECTED FROM EXCESSIVE WIND,
- 4. ALL ASPHALT, BASE COURSE AND OTHER DEBRIS ARE TO BE REMOVED COMPLETELY BELOW PLANTING AREAS TO NATIVE SOIL LEVEL WITH A MINIMUM OF 18" OF IMPORTED TOPSOIL INSTALLED.

SUN, FROST, PHYSICAL DAMAGE AND THEFT UNTIL PLANTED.

- 5. THE CONTRACTOR SHALL BE RESPONSIBLE FOR POSITIVE SURFACE DRAINAGE AT 2% MINIMUM IN
- PLANTING AREAS EXCEPT WHERE SHOWN. THE CONTRACTOR SHALL FURNISH AND APPLY THE APPROPRIATE PRE-EMERGENT HERBICIDE AT RATES PRESCRIBED BY LAW AND THE MANUFACTURER'S RECOMMENDATIONS. 'SURFLAN 75W' IS RECOMMENDED FOR GROUND COVER AND SHRUB AREAS. ALL PRE-EMERGENT HERBICIDES SHALL BE
- ALL PLANTING AREAS SHALL BE ROTOTILLED (OR HAND CULTIVATED UNDER EXISTING TREES) TO A DEPTH OF 8". TAKE CARE NOT TO DAMAGE ROOTS.
- 8. THE CONTRACTOR TO BE RESPONSIBLE FOR OBTAINING A SOILS TEST AND PROVIDING THE APPROPRIATE AMENDMENTS BASED ON THE TEST RESULTS.

APPLIED BY LICENSED OPERATORS UNDER FAVORABLE WEATHER CONDITIONS.


BEFORE EXCAVATING CALL U.S.A. UNDERGROUND SERVICE ALERT 811 TOLL FREE 2 WORKING DAYS BEFORE ALL PLANNED WORK OPERATIONS



- 9. FINISH GRADE OF PLANTED AREAS TO BE ONE (1) INCH BELOW PAVING. WATER SOIL THOROUGHLY BEFORE PLANTING. ALL PLANTS SHALL BE SET AT SUCH A LEVEL THAT AFTER SETTLING THEY BEAR THE SAME RELATIONSHIP TO THE SURROUNDING FINISH GRADE AS THEY BORE TO THE SOIL LINE GRADE IN THE CONTAINER, UNLESS OTHERWISE NOTED.
- 10. IT SHALL BE THE CONTRACTOR'S RESPONSIBILITY TO PROVIDE ADEQUATE DRAINAGE OF ALL PLANTINGS, SUFFICIENT TO INSURE HEALTHY GROWTH.
- 11. NEW LANDSCAPE IRRIGATION SYSTEM SHALL BE INSTALLED AND OPERATIONAL PRIOR TO PLANT MATERIAL INSTALLATION.
- 12. COVER ALL PLANTING AREAS WITH A 3" DEPTH OF APPROVED STABILIZED DECOMPOSED GRANITE FINES MULCH AND DRESS OFF NEATLY.
- 13. A COPY OF THE SOILS TESTING SHALL BE PROVIDED TO THE LANDSCAPE ARCHITECT, CITY OF STOCKTON COMMUNITY DEVELOPMENT DEPARTMENT AND BE ATTACHED TO THE JOB SITE COPY OF THE LANDSCAPE PLANS, FOR INSPECTION PURPOSES.
- 14. A CERTIFICATE OF COMPLETION SHALL BE PROVIDED TO THE CITY OF STOCKTON COMMUNITY DEVELOPMENT DEPARTMENT, BY THE PROJECT LANDSCAPE ARCHITECT. THE CERTIFICATE SHALL INCLUDE ALL REQUIREMENTS AS NOTED IN SECTION 492.9 OF THE MODEL WATER EFFICIENT LANDSCAPE ORDINANCE.

I COMPLY WITH THE CRITERIA OF THE MODEL WATER EFFICIENT LANDSCAPE ORDINANCE AND APPLY THEM FOR THE EFFICENT USE OF WATER IN THE LANDSCAPE AND IRRIGATION DESIGN PLANS.

ROBERT J. NORBUTAS, JR., RLA 5595

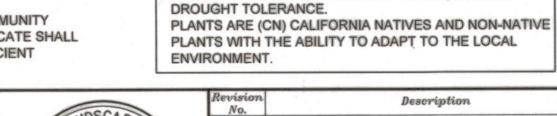

DEXP. 11/30/22

DATE SIGNED: 02/02/22

PLANT SELECTION NOTE

PLANTS ARE SELECTED FOR LOW WATER USE AND

TOTAL IRRIGATED LANDSCAPE AREA

LANDSCAPE SUMMARY

701 UNIVERSITY AVENUE, SUITE 200 SACRAMENTO, CALIFORNIA 95825 (916) 381-9100 FAX: (916)381-9180


DECORATIVE BOULDERS


(A) 3'x1.5'

(B)2'x1.5' (C)2'x1'

SEVEN (7) PROPOSED LANDSCAPE-QUALITY DECORATIVE BOULDERS (MIX PER PLAN (A)3'x1.5', (B)2'x1.5', (C)2'x1'), CONTRACTOR TO COORDINATE WITH CITY AND PROJECT LANDSCAPE ARCHITECT FOR FINAL FIELD PLACEMENT. LINCOLN ST./EIGHTH ST. ROUNDABOUT PROJECT PLANTING PLAN PUBLIC WORKS DEPARTMENT CITY OF STOCKTON, CALIFORNIA SCALE: 1"-'10' DESIGNED BY: RJN DRAWN BY: RJN CHECKED BY: RJN STOCKTON, CALIFORNIA

MARK **THOMAS**

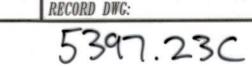

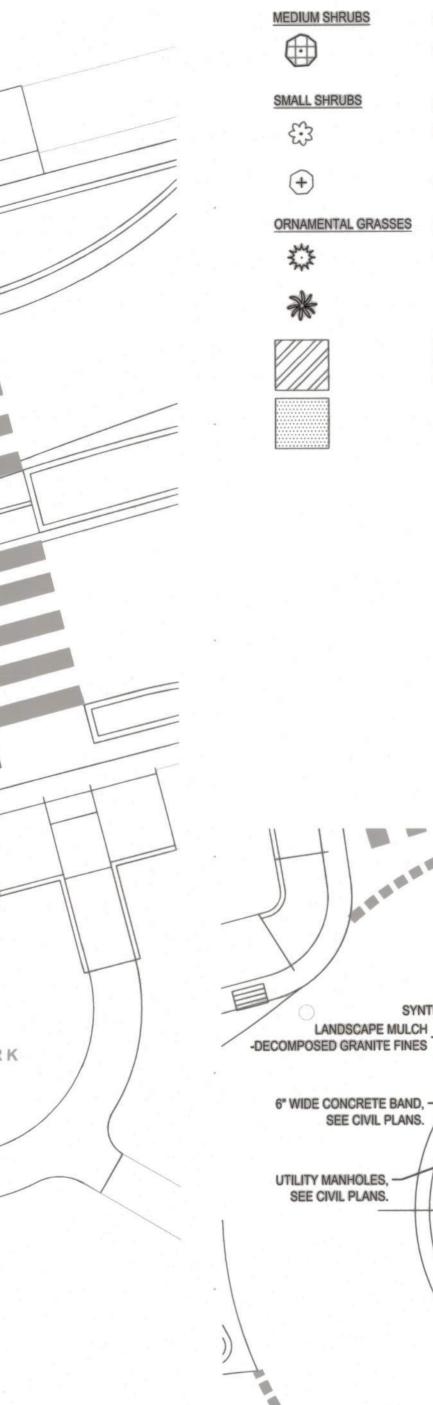

SHRUB & GROUNDCOVER LEGEND

LANDSCAPE MULCH

SYNTHETIC TURF

SYNTHETIC TURF -

LAYOUT PLAN

Fines with Organic Stabilizer. 3" thick layer.

BOTANICAL / COMMON NAME

BOTANICAL / COMMON NAME

BOTANICAL / COMMON NAME

HEM ORO Hemerocallis x 'Stella de Oro' / Stella de Oro Daylily


PEN MAR Penstemon heterophyllus 'Margarita BOP' / Margarita BOP Penstemon


Dianella tasmanica 'Variegata' / Variegated Flax Lily

LOM PLA Lomandra longifolia 'Platinum Beauty' / Platinum Beauty


Landscape Planting area to be installed with Decomposed Granite

Salvia leucantha / Mexican Bush Sage

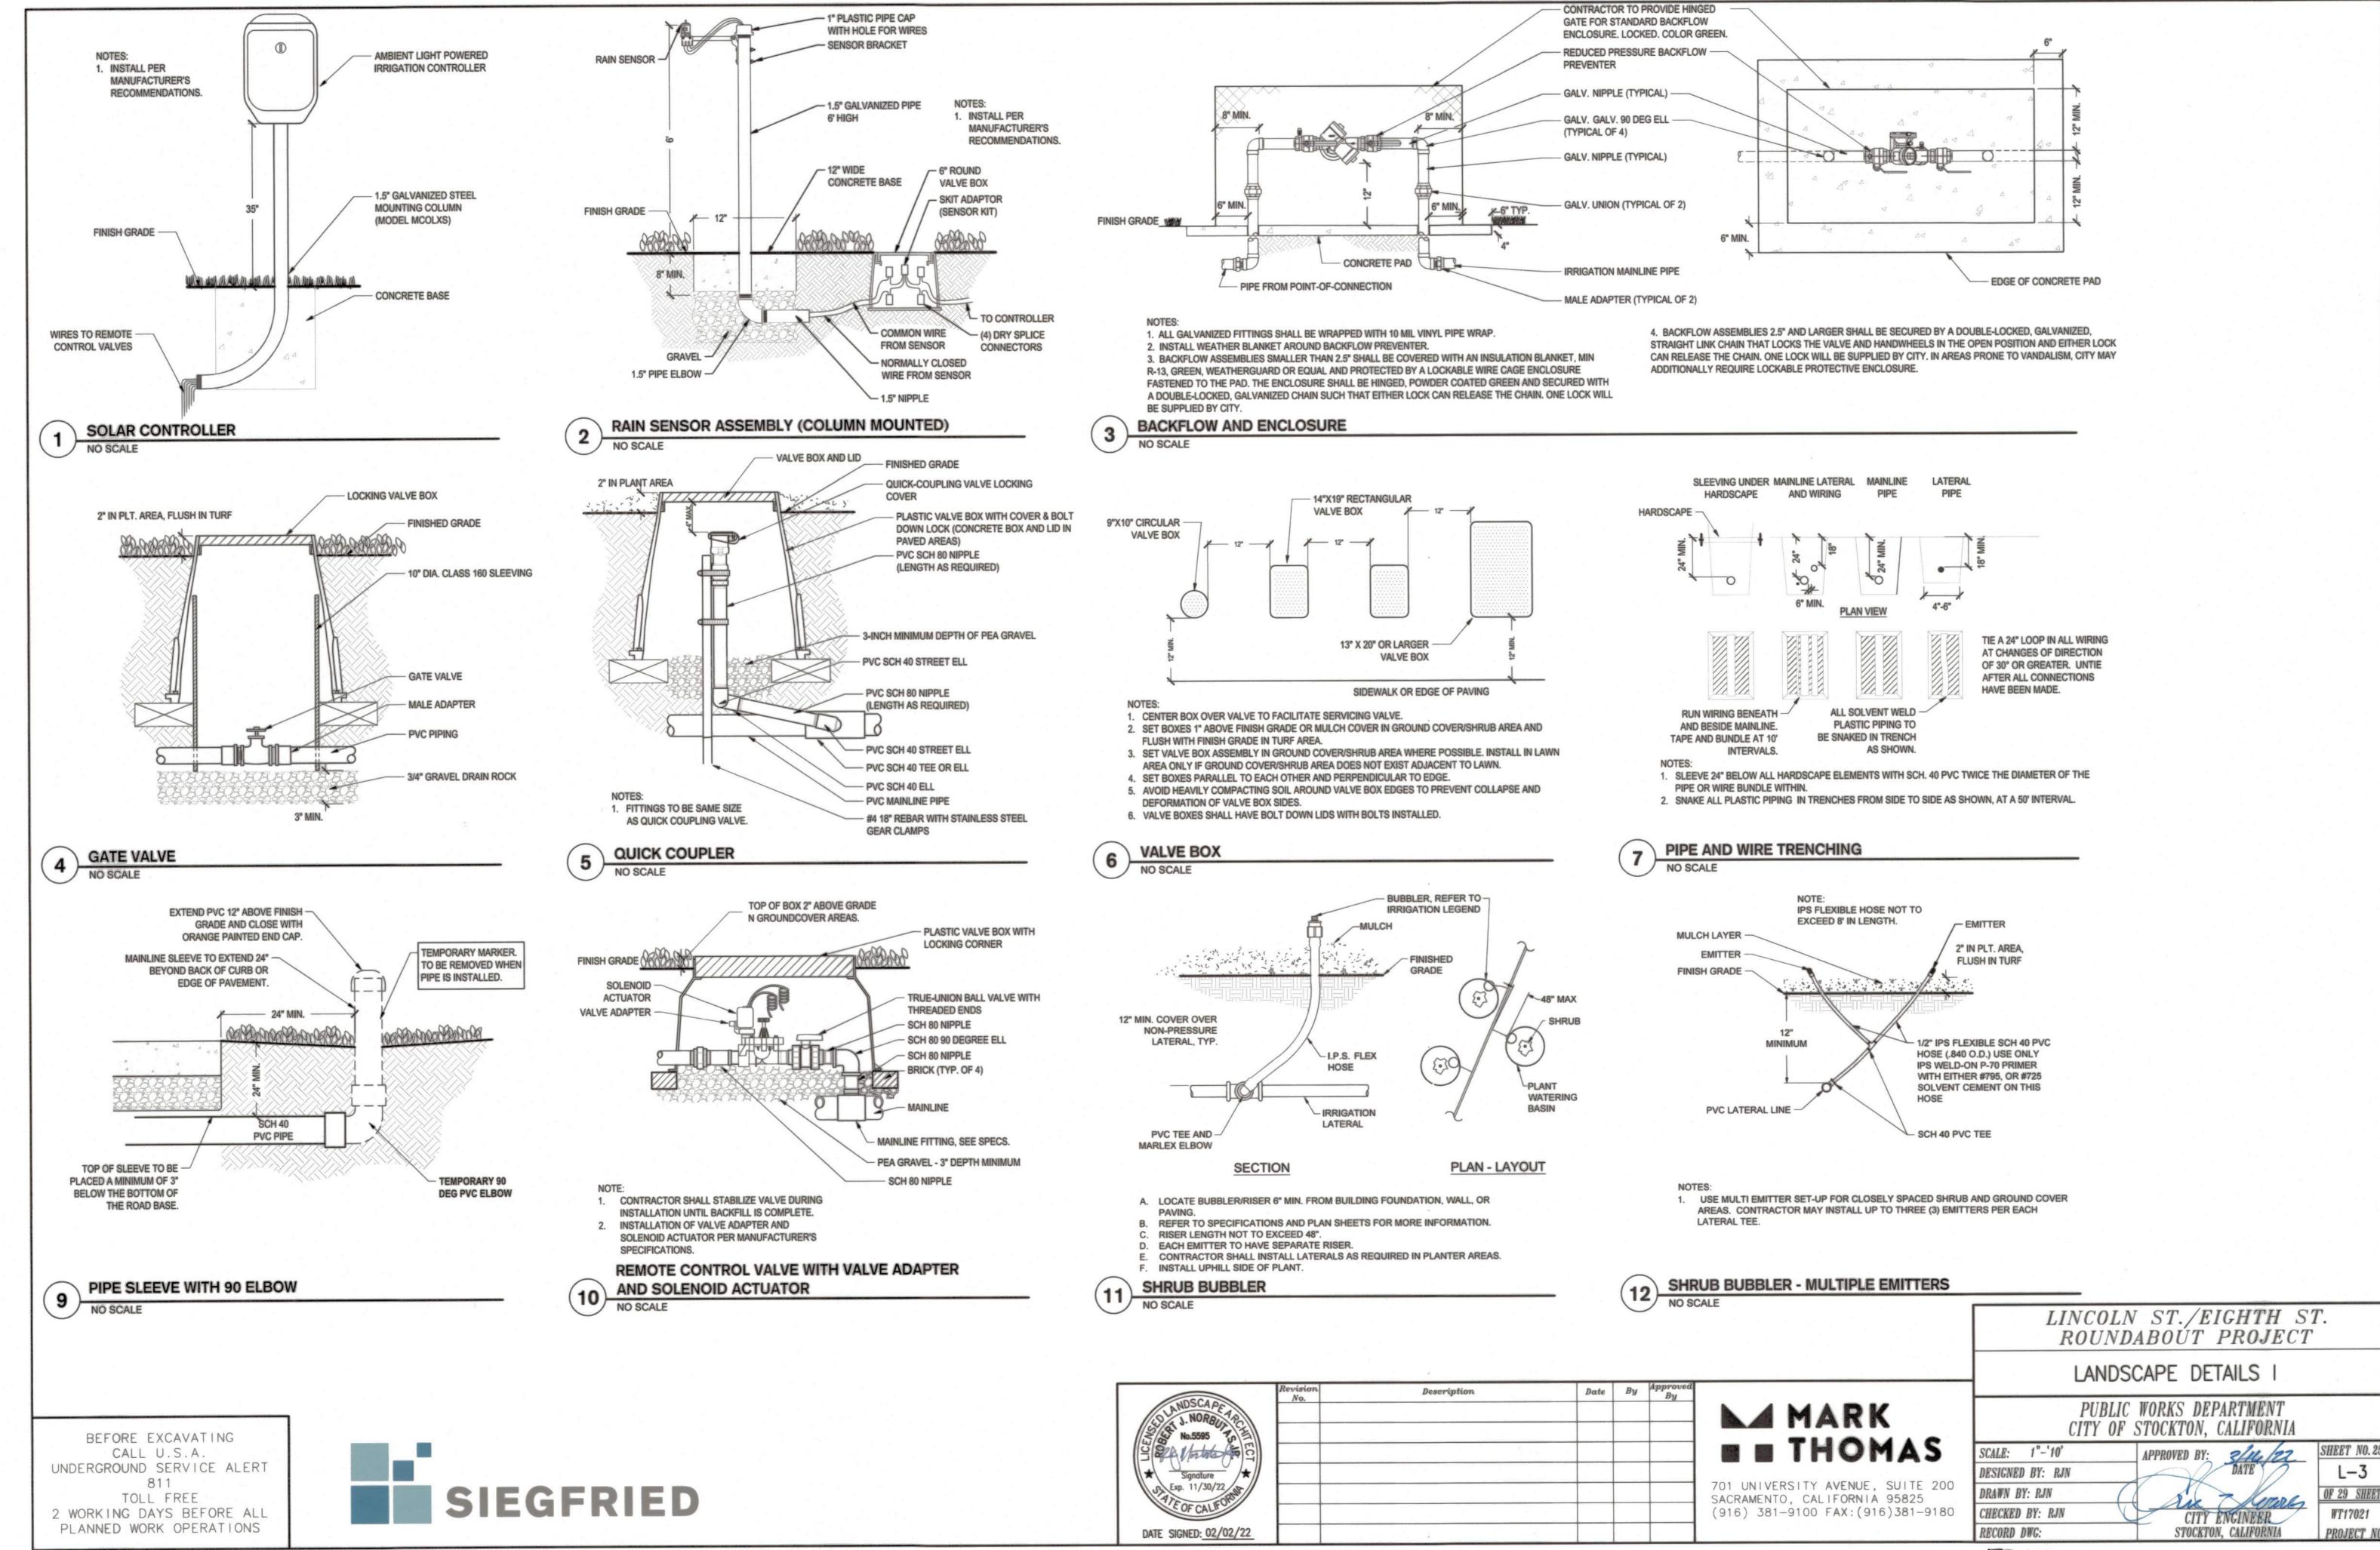

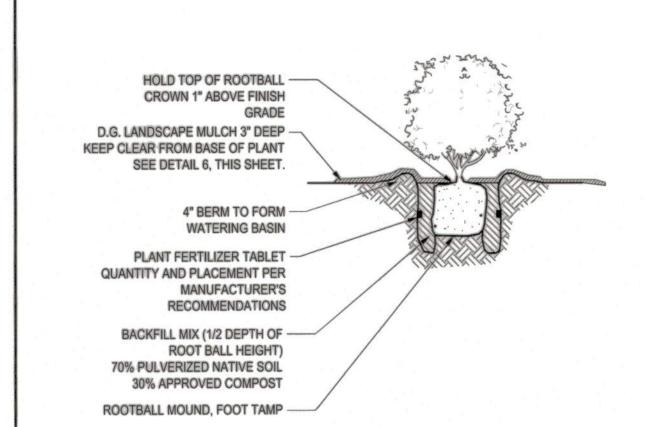

- DRY STACK RANDOM BOULDER SIZES. BOULDER LOCATION PER PLAN. BURY 1/3 OF TOTAL HEIGHT. ±24" WIDE - MINIMUM 12" Ø TYPICAL SUBGRADE -**COMPACTED TO 95%** LOCALLY QUARRIED WITHIN 100 MILES. PROVIDE SAMPLE TO BE APPROVED BY OWNERS REPRESENTATIVE. NATURAL GRAY TO BROWN COLOR.

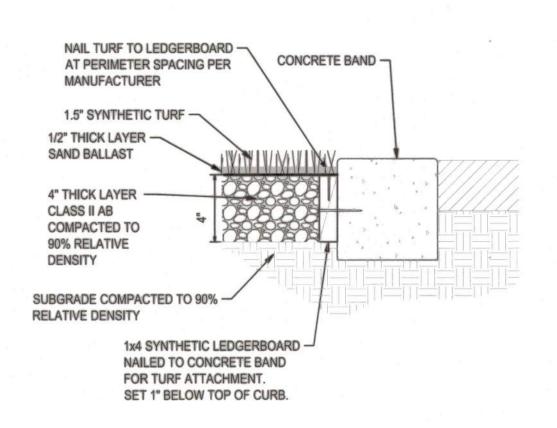

DECOMPOSED GRANITE FINES WITH STABILIZER, CONCRETE BAND -**COMPACT TO 95%** RELATIVE DENSITY FINISH GRADE SUBGRADE COMPACTED TO 90% RELATIVE

SHRUB PLANTING


LANDSCAPE BOULDER

SYNTHETIC TURF NO SCALE

DECOMPOSED GRANITE LANDSCAPE MULCH

BEFORE EXCAVATING CALL U.S.A. UNDERGROUND SERVICE ALERT 811 TOLL FREE 2 WORKING DAYS BEFORE ALL PLANNED WORK OPERATIONS



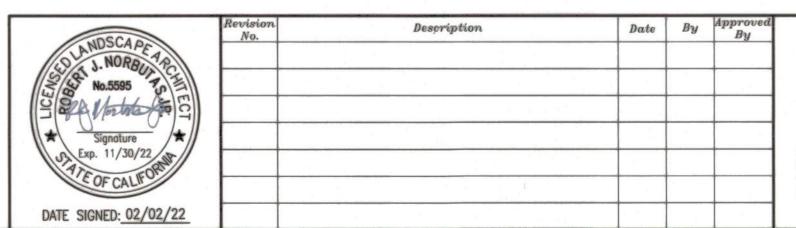



LANDSCAPE DETAILS II PUBLIC WORKS DEPARTMENT CITY OF STOCKTON, CALIFORNIA SCALE: 1"-'10' DESIGNED BY: RJN DRAWN BY: RJN CHECKED BY: RJN

LINCOLN ST./EIGHTH ST. ROUNDABOUT PROJECT

5397.25C

RECORD DWG:

